REDUCTIONS REQUESTED BY SPECIAL PERMIT

- Zoning Bylaw 390-6.1.9: FRONT YARD REDUCED TO 50'/SIDE YARD
- Zoning Bylaw 390-6.4.B.9(i): 26% SHADING WHERE 50% PARKING
- Zoning Bylaw 390-18.5.D.2: ON PREMISE SIGN GREATER THAN 10 SF

RECEIVED 06/21/23 Planning Dept Exhibit # 5

SCALE: AS NOTED

SIMPLY SAFER LAWN CARE CT LANDSCAPING HELPING HANDS > /

SITE DEVELOPMENT PLAN OF LAND 10 Commerce Boulevard Wrentham, WA

APRIL 19, 2023

CIVIL ENGINEER BAY COLONY GROUP, Inc. FOUR SCHOOL STREET, P.O. BOX 9136 FOXBOROUGH, MA 02035 (508) 543-3939

LOCUS MAP $1" = 200'\pm$

ARCHITECT NDA ARCHITECTS

100 FOXBOROUGH BOULEVARD FOXBOROUGH, MA 02035 (508) 620-9705

DEDHAM, MA 02026 (508) 736-6144

DESCRIPTION

COVER SHEET

SHEET A-6 | BUILDING RENDERING

LEGEND & GENERAL NOTES

EXISTING CONDITIONS PLAN

LAYOUT & GRADING PLAN

LANDSCAPE ARCHITECT RADNER DESIGN ASSOCIATES 3 ALLIED DRIVE, SUITE 203

COMMERCE BLVD

ASSESSORS REF: MAP 0-6, BLOCK 4, LOT 6

ZONING: C-2

DRAINAGE & UTILITY PLAN	4-19-2023
DETAILS	4-19-2023
SWPPP & SNOW STORAGE PLAN	4-19-2023
SWPPP & SNOW STORAGE PLAN	4-19-2023
CERTIFICATE OF ACTION	NOT INCLUDED
HERS	
LANDSCAPE ARCHITECT	
NOTES & DETAILS	4-19-2023
LANDSCAPE PLAN - SHADING CALCULATION	4-19-2023
LANDSCAPE PLAN — LANDSCAPE AREA CALCULATION	4-19-2023
SIGHT LIGHTING PHOTOMETRIC PLAN	4-19-2023
PLANTING PLAN	4-19-2023
ARCHITECT	
FLOOR PLAN	4-19-2023
BUILDING RENDERING	4-19-2023
BUILDING RENDERING	4-19-2023
BUILDING RENDERING	4-19-2023
	DETAILS DETAILS DETAILS DETAILS SWPPP & SNOW STORAGE PLAN SWPPP & SNOW STORAGE PLAN CERTIFICATE OF ACTION HERS LANDSCAPE ARCHITECT NOTES & DETAILS LANDSCAPE PLAN — SHADING CALCULATION LANDSCAPE PLAN — LANDSCAPE AREA CALCULATION SIGHT LIGHTING PHOTOMETRIC PLAN PLANTING PLAN ARCHITECT FLOOR PLAN BUILDING RENDERING BUILDING RENDERING

THE LAST REVISED DATE FOR PLANS IN THIS SET IS: 4-19-2023

PROJECT: 10 Commerce Blvd Wrentham, Massachusetts

WBH, LLC 320 SOUTH STREET PLAINVILLE, MA 02762

<u>APPLICANT:</u>

EDGEWOOD DEVELOPMENT COMPANY, LLC 320 SOUTH STREET PLAINVILLE, MA 02762





FOXBOROUGH, MA 02035

WRENTHAM PLANNING BOARD

HEREBY CERTIFY THAT 20 DAYS HAVE APPROVAL AND THAT NO APPEAL HAS BEEN FILED IN THIS OFFICE.

LAST REVISED

4-19-2023

4-19-2023


4-19-2023

4-19-2023

4-19-2023

4-19-2023

DATE WRENTHAM TOWN CLERK

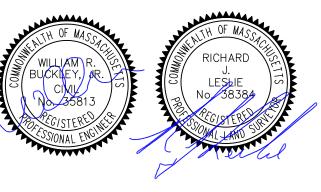

DRAWING TITLE

Cover Sheet

APRIL 19, 2023 21-0219F

GENERAL NOTES

- TOPOGRAPHICAL INFORMATION OBTAINED FROM AN ON THE GROUND SURVEY BY THIS OFFICE IN JUNE-JULY 2017.
- THERE ARE NO RESOURCE AREAS AS LISTED UNDER THE WETLANDS PROTECTION ACT WITHIN 200' OF THE PROJECT.
- UNDERGROUND UTILITIES ARE SHOWN HEREON AS COMPILED FROM RECORD PLANS AND VISIBLE UTILITY STRUCTURES. BAY COLONY GROUP DOES NOTE WARRANT THE ACTUAL DEPTH AND LOCATIONS OF ANY UTILITIES SHOWN HEREON. CONTACT DIGSAFE AT 1-800-322-4844 AT LEAST 72 HOURS, SATURDAYS, SUNDAYS AND HOLIDAYS EXCLUDED, PRIOR TO EXCAVATING AT ANY LOCATION. A COPY OF THE DIGSAFE PROJECT REFERENCE NUMBER(S) SHALL BE GIVEN TO THE OWNER PRIOR TO EXCAVATION.
- WHERE AN EXISTING UNDERGROUND UTILITY IS FOUND TO CONFLICT WITH THE PROPOSED WORK, THE LOCATION, ELEVATION AND SIZE OF THE UTILITY SHALL BE ACCURATELY DETERMINED WITHOUT DELAY BY THE CONTRACTOR. AND THE INFORMATION FURNISHED TO THE ENGINEER IMMEDIATELY.
- TEST PITS TO LOCATED EXISTING UTILITIES MAY BE ORDERED BY THE ENGINEER.
- THE CONTRACTOR SHALL MAKE ALL ARRANGEMENTS FOR THE ALTERATION AND ADJUSTMENT OF GAS, ELECTRIC. TELEPHONE AND ANY OTHER PRIVATE UTILITIES BY THE RESPECTIVE COMPANIES.
- AREAS OUTSIDE THE LIMITS OF THE PROPOSED WORK DISTURBED BY THE CONTRACTOR'S OPERATIONS SHALL BE RESTORED BY THE CONTRACTOR TO THEIR ORIGINAL CONDITIONS AT THE CONTRACTOR'S EXPENSE.
- STONE WALLS, FENCES, MAIL BOXES, SIGNS, CURBS, LIGHT POLES ETC.. SHALL BE REMOVED AND REPLACED AS NECESSARY TO PERFORM THE WORK.
- ALL PAVEMENT DISTURBED BY THE CONTRACTOR'S OPERATIONS SHALL BE REPLACED IN ACCORDANCE WITH THE SPECIFICATIONS AND AS SHOWN ON THE DRAWINGS.
- CONTRACTOR SHALL NOT STORE ANY EQUIPMENT, MATERIALS, SUPPLIES ON DRAINAGE STRUCTURES OR WITHIN 100 FEET OF WETLANDS.
- OPENINGS FOR PIPE IN PRECAST CONCRETE STRUCTURES SHALL BE CAST IN THE REQUIRED LOCATIONS DURING MANHOLE MANUFACTURE. FIELD CUT OPENINGS WILL NOT BE PERMITTED UNLESS APPROVED BY THE ENGINEER.
- IN PAVED AND GRAVEL AREAS THE TOP OF THE STRUCTURE COVERS SHALL BE SET FLUSH WITH THE PAVED SURFACE. IN CROSS-COUNTRY AREAS THE TOP OF THE COVER SHALL EXTEND 6 INCHES ABOVE FINISHED GRADE, OR AS SHOWN ON THE DRAWINGS, OR AS DIRECTED BY THE ENGINEER.
- THE TERM "PROPOSED" (PROP or PR-) SHALL BE UNDERSTOOD TO MEAN WORK TO BE CONSTRUCTED USING NEW MATERIALS OR, WHERE APPLICABLE, RE-USING EXISTING MATERIALS IDENTIFIED ON THE PLAN AS R&R (REMOVE AND RESET).
- THIS PLAN IS SUBJECT TO A CERTIFICATE OF ACTION DATED xxxxxx ISSUED BY THE TOWN OF WRENTHAM PLANNING BOARD, AN APPROVAL FROM THE WRENTHAM BOARD OF HEALTH DATED XXXX., THOSE DOCUMENTS SHALL BE CONSIDERED PART OF THIS PLAN.

PAVEMENT MARKINGS

- SWL SWL SOLID WHITE LINE 6" STATE HIGHWAY, 4" LOCAL STREETS
- SYL SYL SOLID YELLOW LINE 6" STATE HIGHWAY, 4" LOCAL STREETS
- DWL DWL DOTTED WHITE LINE 6" (2' STRIPE w/4' GAP) STATE HIGHWAY
- DOTTED WHITE LINE -4" (2' STRIPE w/4' GAP) LOCAL STREETS WLDL WHITE LANE DELINEATION LINE -6" (3' STRIPE w/9' GAP) STATE HIGHWAY
- WHITE LANE DELINEATION LINE -4" (3' STRIPE w/9' GAP) LOCAL STREETS
- DDYL DOUBLE DOTTED YELLOW LINE -6" (2' STRIPE w/4' GAP) STATE HIGHWAY DOUBLE DOTTED YELLOW LINE - 4" (2' STRIPE w/4' GAP) LOCAL STREETS
- BWLL BROKEN WHITE LANE LINE 6" (10' STRIPE w/30' GAP) STATE HIGHWAY BROKEN WHITE LANE LINE -4" (10' STRIPE w/30' GAP) LOCAL STREETS
- SWLL SOLID WHITE LANE LINE -6" STATE HIGHWAY, 4" LOCAL STREETS
- SWEL SOLID WHITE EDGE LINE -6" STATE HIGHWAY, 4" LOCAL STREETS
- SWGL SOLID WHITE GORE LINE 12"
- SYEL SOLID YELLOW EDGE LINE 6" STATE HIGHWAY, 4" LOCAL STREETS
- SYGL SOLID YELLOW GORE LINE 12"
- DYL DOUBLE YELLOW LINE 2-6" LINES STATE HIGHWAY DOUBLE YELLOW LINE - 2-4" LINES LOCAL STREETS
- ₽ PAVEMENT ARROW AND LEGEND

SYMBOLS & LEGEND

EXISTING

n.t.s. - NOT TO SCALE T.B.M. - TEMPORARY BENCH MARK BOUND (TYPE NOTED) - STAKE & STONE DH ● - DRILL HOLE IP ◎ - IRON PIPE/PIN MHB - MASS HIGHWAY BOUND (fd) – FOUND (set) - SET IN PLACE UTILITY POLE UPLP - UTILITY POLE/LIGHT POLE UTILITY POLE - WELL NOW OR FORMERLY - TREE (SIZE NOTED) (rec) — RECORD - DRAIN MANHOLE - TELEPHONE MANHOLE - ELECTRIC MANHOLE - SEWER MANHOLE - CATCH BASIN - WATER GATE - WATER SERVICE - GAS GATE - EXISTING HYDRANT - SLOPED GRANITE CURBING VERTICAL GRANITE CURBING PVC - POLYVINYL CHLORIDE PIPE - CORRUGATED METAL PIPE VCP - VITREOUS CLAY PIPE CIF - CHAIN LINK FENCE OHW - OVERHEAD WIRE SIGN - - SIGN (SIZE & TYPE NOTED) - TEST PIT ---- D --- - DRAIN PIPE (SIZE & TYPE NOTED) ----- S ----- - SEWER PIPE (SIZE & TYPE NOTED) ——— E ——— — ELECTRIC DUCT (SIZE & TYPE NOTED) ——— G ——— — GAS MAIN (SIZE & TYPE NOTED) — WATER MAIN (SIZE & TYPE NOTED) — T — TELEPHONE DUCT - EDGE OF TREELINE - GUARD-RAIL (TYPE NOTED) TO RAILROAD TRACKS

PROPOSED

<u> </u>	1 0	POSED
n + 0		NOT TO SCALE
		NOT TO SCALE
T.B.M. □	_	TEMPORARY BENCH MARK CONCRETE BOUND (UNLESS NOTED)
		STAKE & STONE
DH 💿	_	DRILL HOLE
		IRON PIPE/PIN
		MASS HIGHWAY BOUND
<u></u> s∕n	_	STAKE & NAIL
(fd)	_	FOUND
(set)	_	SET IN PLACE
\bigcirc	_	UTILITY POLE
UPLP	_	UTILITY POLE/LIGHT POLE
UP	_	UTILITY POLE
	_	WELL
n/f	_	NOW OR FORMERLY
	_	TREE (SIZE NOTED)
	_	CABLE MANHOLE
\bigcirc	_	DRAIN MANHOLE
	_	TELEPHONE MANHOLE
E	_	ELECTRIC MANHOLE
S		SEWER MANHOLE
		CATCH BASIN OR AREA DRAIN
WG ⋈		WATER GATE
		WATER SERVICE
		GAS GATE
γ_{Y} \circ		PROPOSED HYDRANT
		AREA DRAIN (NYOPLAST/ADS)
		CATCH BASIN
		HOT MIX ASPHALT
		MONOLITHIC BITUMINOUS CURBING
		MONOLITHIC CONCRETE CURBING
		VERTICAL GRANITE CURBING VERTICAL CONCRETE CURBING
		CORRUGATED METAL PIPE
		POST INDICATOR VALVE
		POLYVINYL CHLORIDE PIPE
		CHAIN LINK FENCE
		OVERHEAD WIRE
RDMH	_	ROOF DRAIN MANHOLE (NYOPLAST)
R&R	_	REMOVE AND RE-USE
R&S	_	REMOVE AND STACK
SIGN 	_	SIGN (SIZE & TYPE NOTED)
—— D ——	_	DRAIN PIPE (SIZE & TYPE NOTED)
		DRAIN PIPE - ROOF (SIZE & TYPE NOTED)
—— S ——	_	SEWER PIPE (SIZE & TYPE NOTED)
—— E ——	_	ELECTRIC DUCT (SIZE & TYPE NOTED)
——GAS——	_	GAS MAIN (SIZE & TYPE NOTED)
—— W ——	_	WATER MAIN (SIZE & TYPE NOTED)
— T —	_	TELEPHONE DUCT
000000000000000000000000000000000000000	_	STONE WALL
$\cdots \cdots$	_	EDGE OF TREELINE
0 0 0 0	_	GUARD-RAIL (TYPE NOTED)
	_	RETAINING WALL (SIZE & TYPE NOTED)
		BARBED WIRE FENCE
		STOCKADE FENCE
——u—u—u—u——	_	SIOUNAUL I ENUE

WBH, LLC 320 SOUTH STREET PLAINVILLE. MA 02762 <u>APPLICANT:</u> **EDGEWOOD** DEVELOPMENT COMPANY, LLC 320 SOUTH STREET PLAINVILLE, MA 02762


PROJECT:

<u>OWNER:</u>

Wrentham,

Massachusetts

10 Commerce Blvd

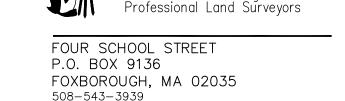


Bay Colony Group, Inc.

DATE APPROVED: _ DATE ENDORSED: ___ WRENTHAM PLANNING BOARD

I HEREBY CERTIFY THAT 20 DAYS HAVE ELAPSED SINCE PLANNING BOARD APPROVAL AND THAT NO APPEAL HAS BEEN FILED IN THIS OFFICE.

DATE WRENTHAM TOWN CLERK

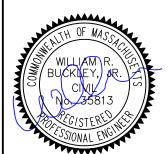


DRAWING TITLE

Legend & General Notes

SCALE: NTS

21-0219F

APRIL 19, 2023 SHEET NUMBER

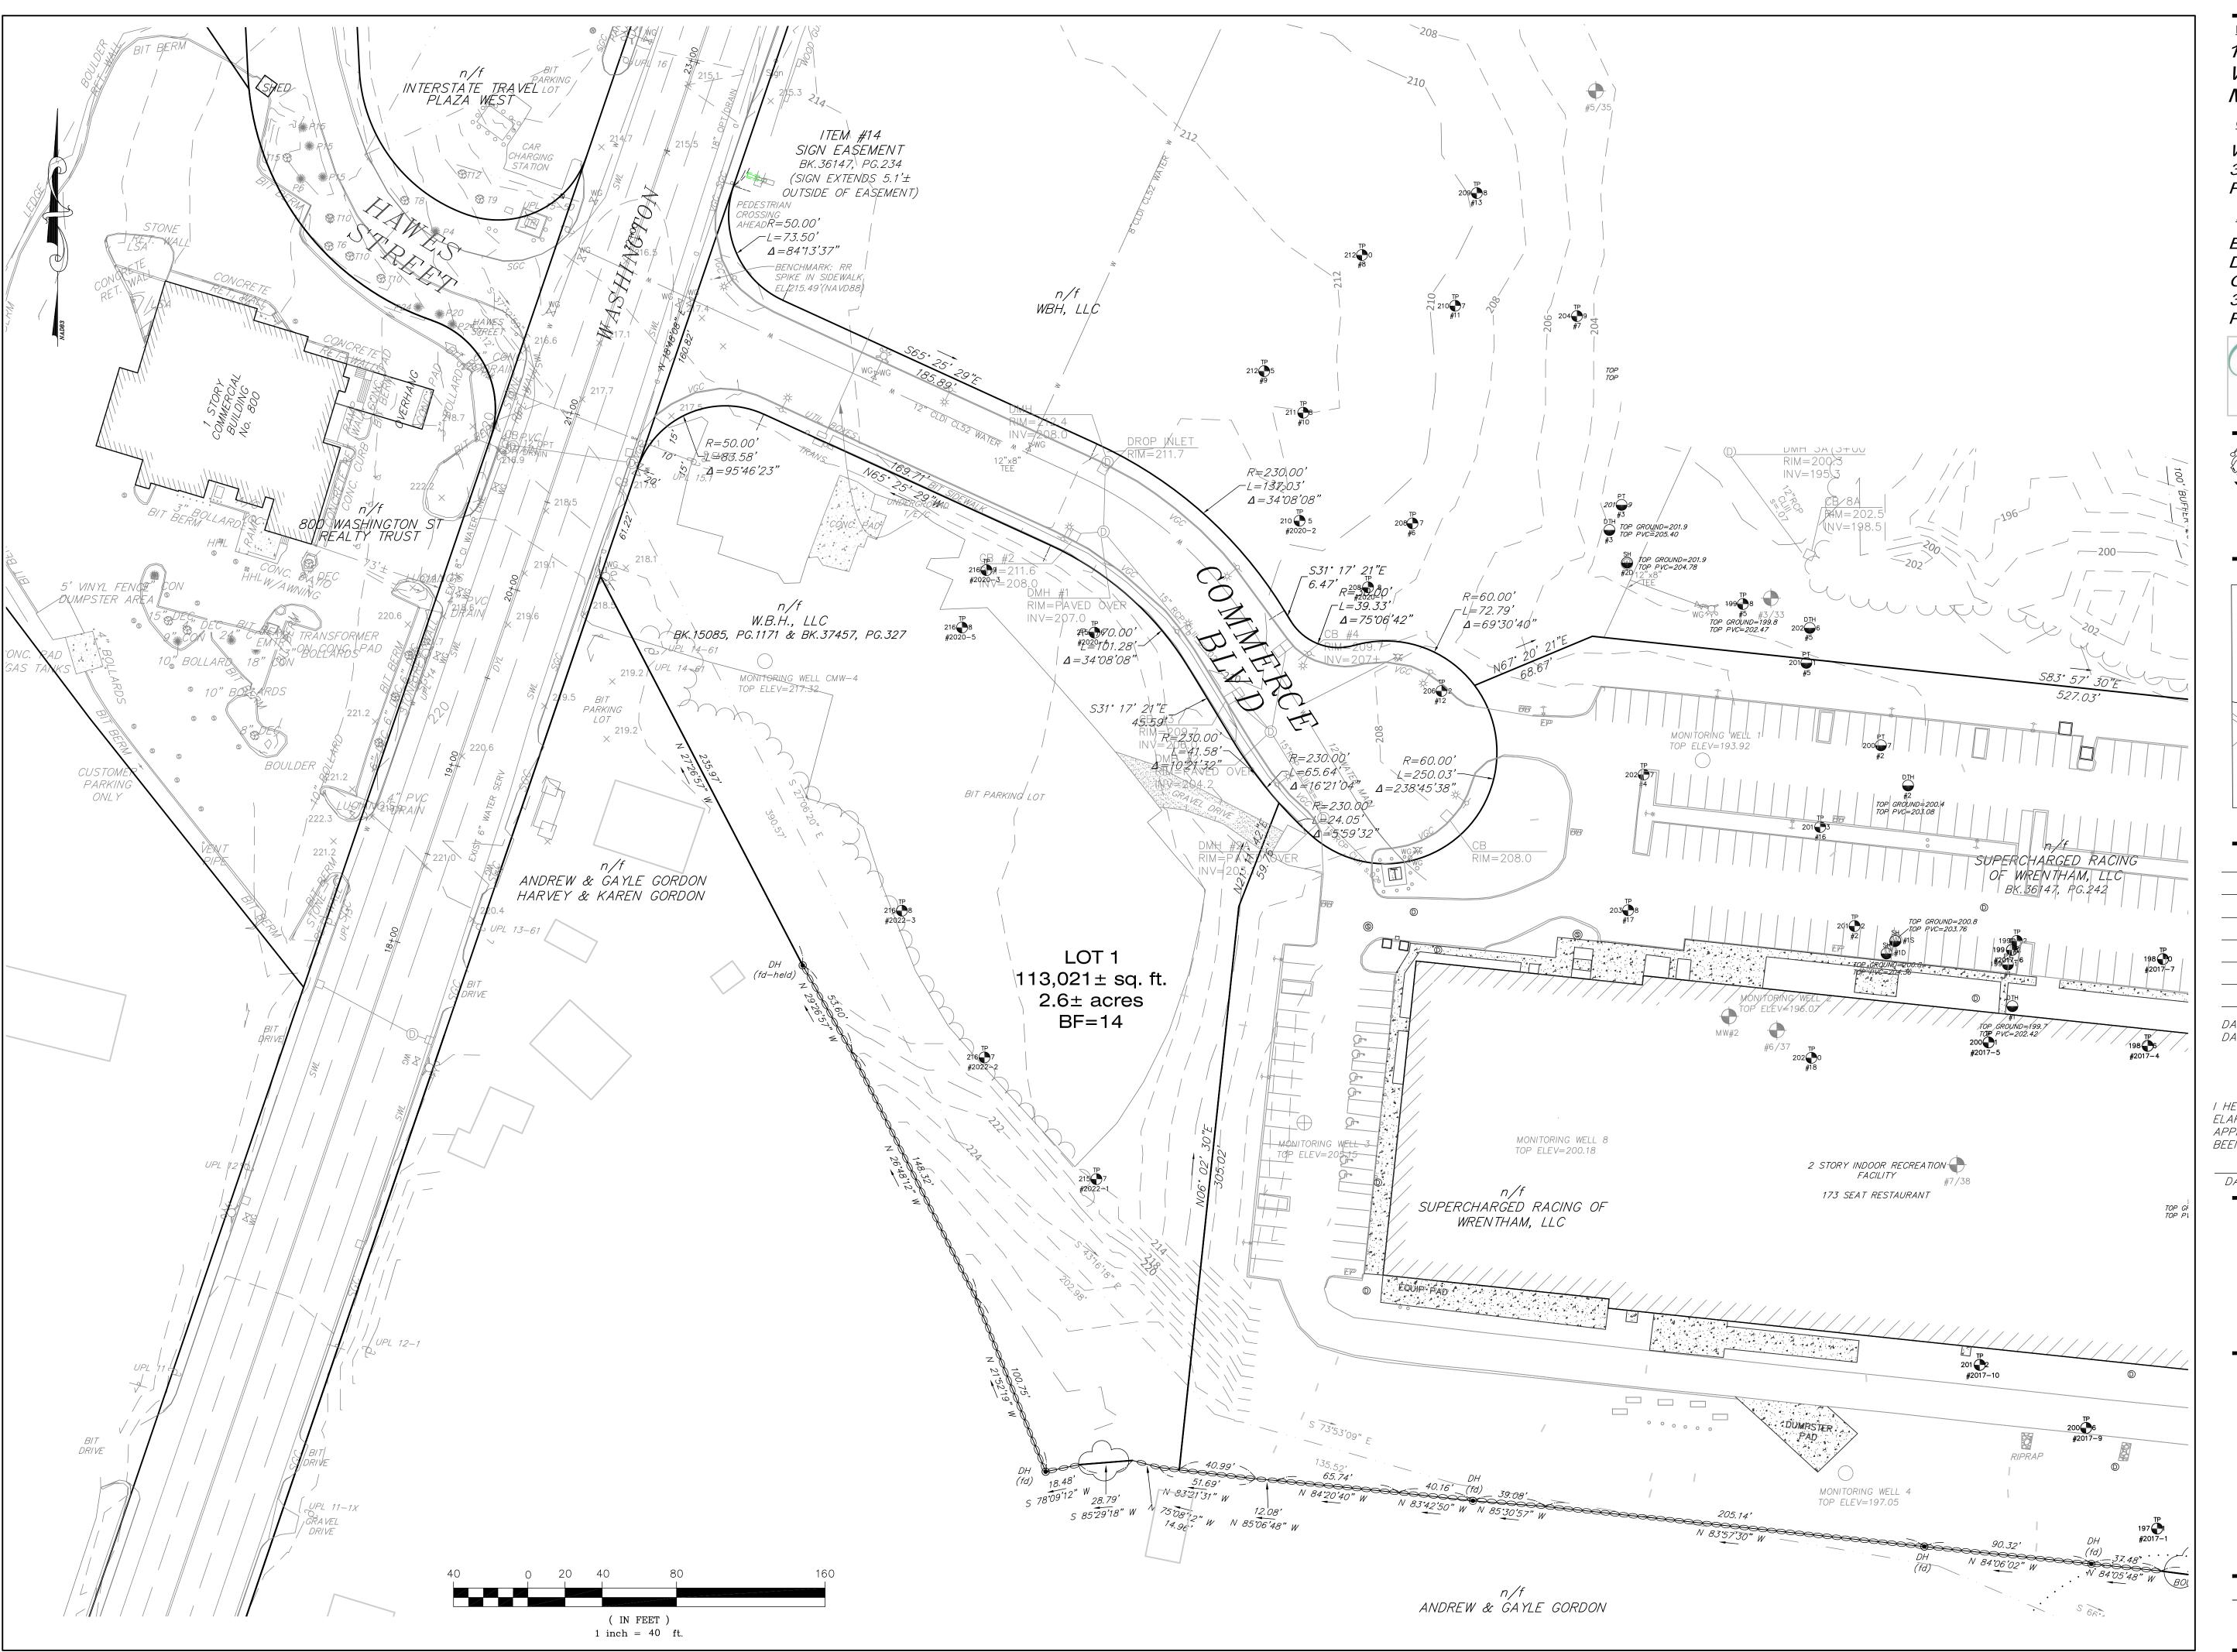

10 Commerce Blvd Wrentham, Massachusetts

OWNER:

WBH, LLC 320 SOUTH STREET PLAINVILLE, MA 02762


<u>APPLICANT:</u>

EDGEWOOD DEVELOPMENT COMPANY, LLC 320 SOUTH STREET PLAINVILLE, MA 02762






FOUR SCHOOL STREET P.O. BOX 9136 FOXBOROUGH, MA 02035 508-543-3939

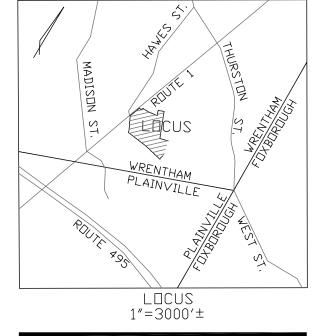

DATE APPROVED: _____ DATE ENDORSED: ____ WRENTHAM PLANNING BOARD

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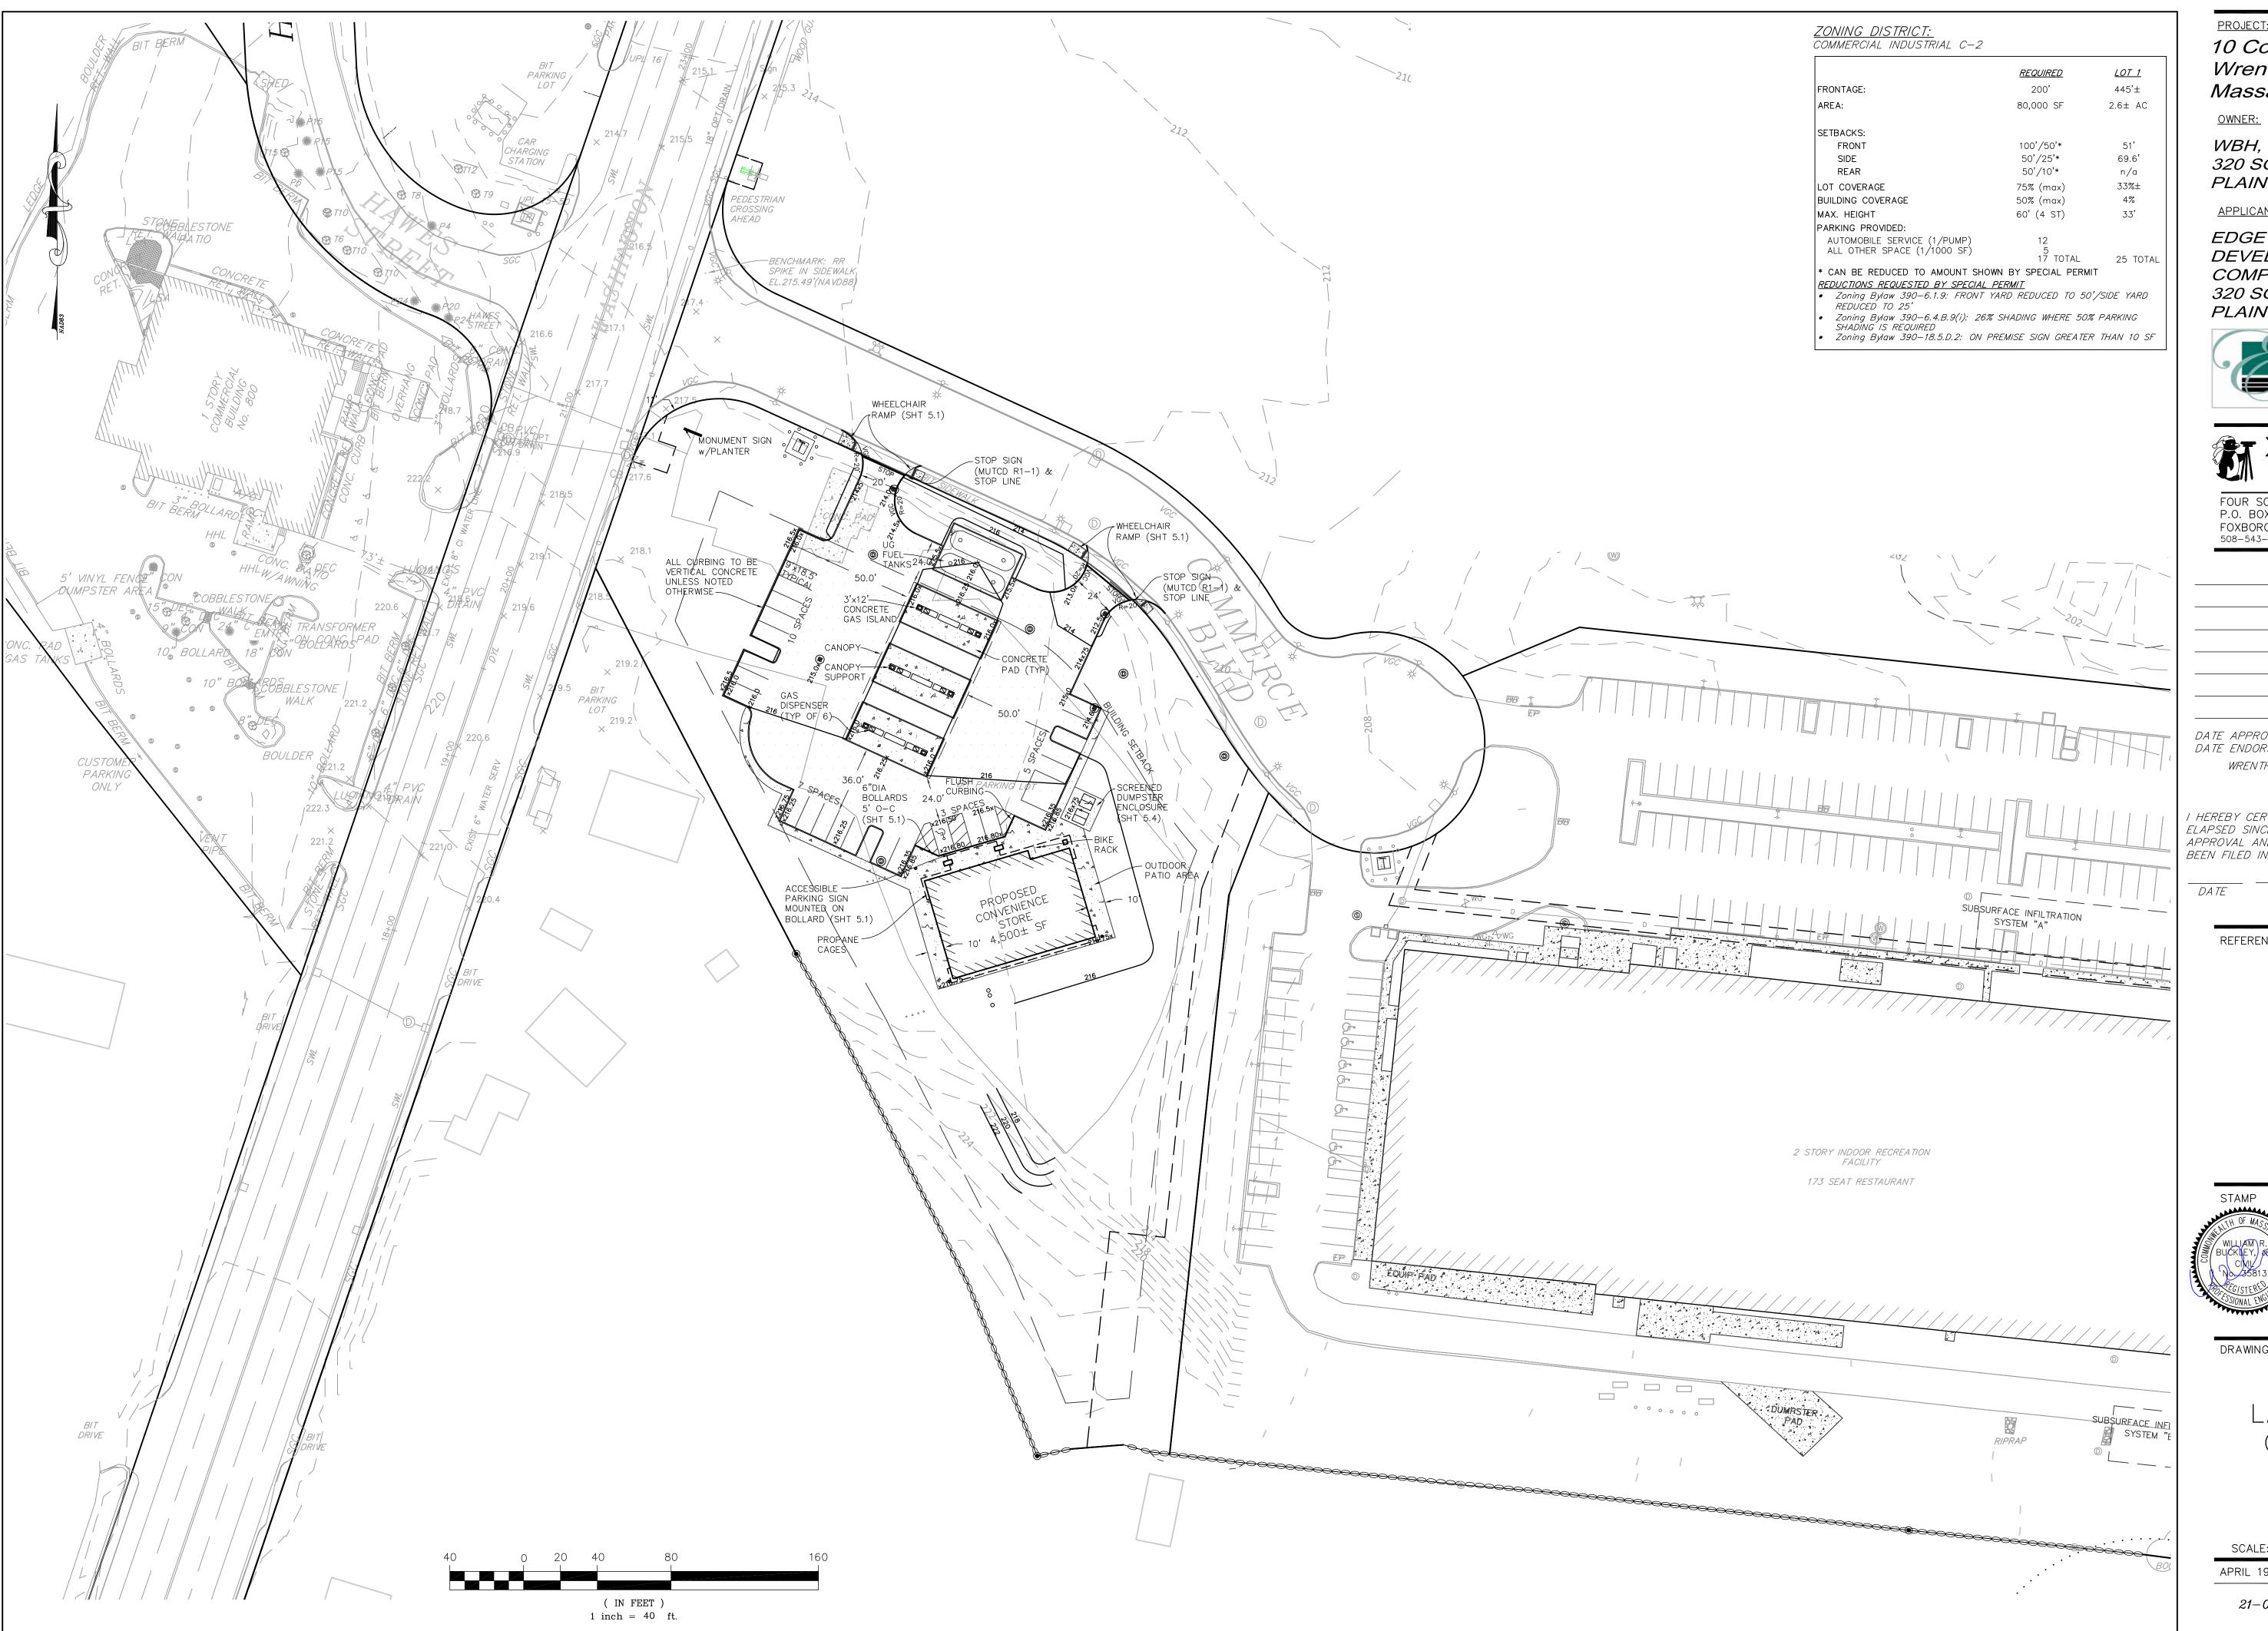


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EXISTING CONDITIONS PLAN

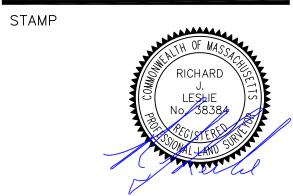SCA	LE:	1"=4
APRIL	19,	202

21-0219A SHEET NUMB



10 Commerce Blvd Wrentham, Massachusetts

WBH, LLC 320 SOUTH STREET PLAINVILLE, MA 02762

<u>APPLICANT:</u>

EDGEWOOD DEVELOPMENT COMPANY, LLC 320 SOUTH STREET PLAINVILLE, MA 02762






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REFERENCES






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LAYOUT & GRADING PLAN

SCALE: 1"=40'

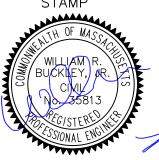21-0219A

APRIL 19, 2023

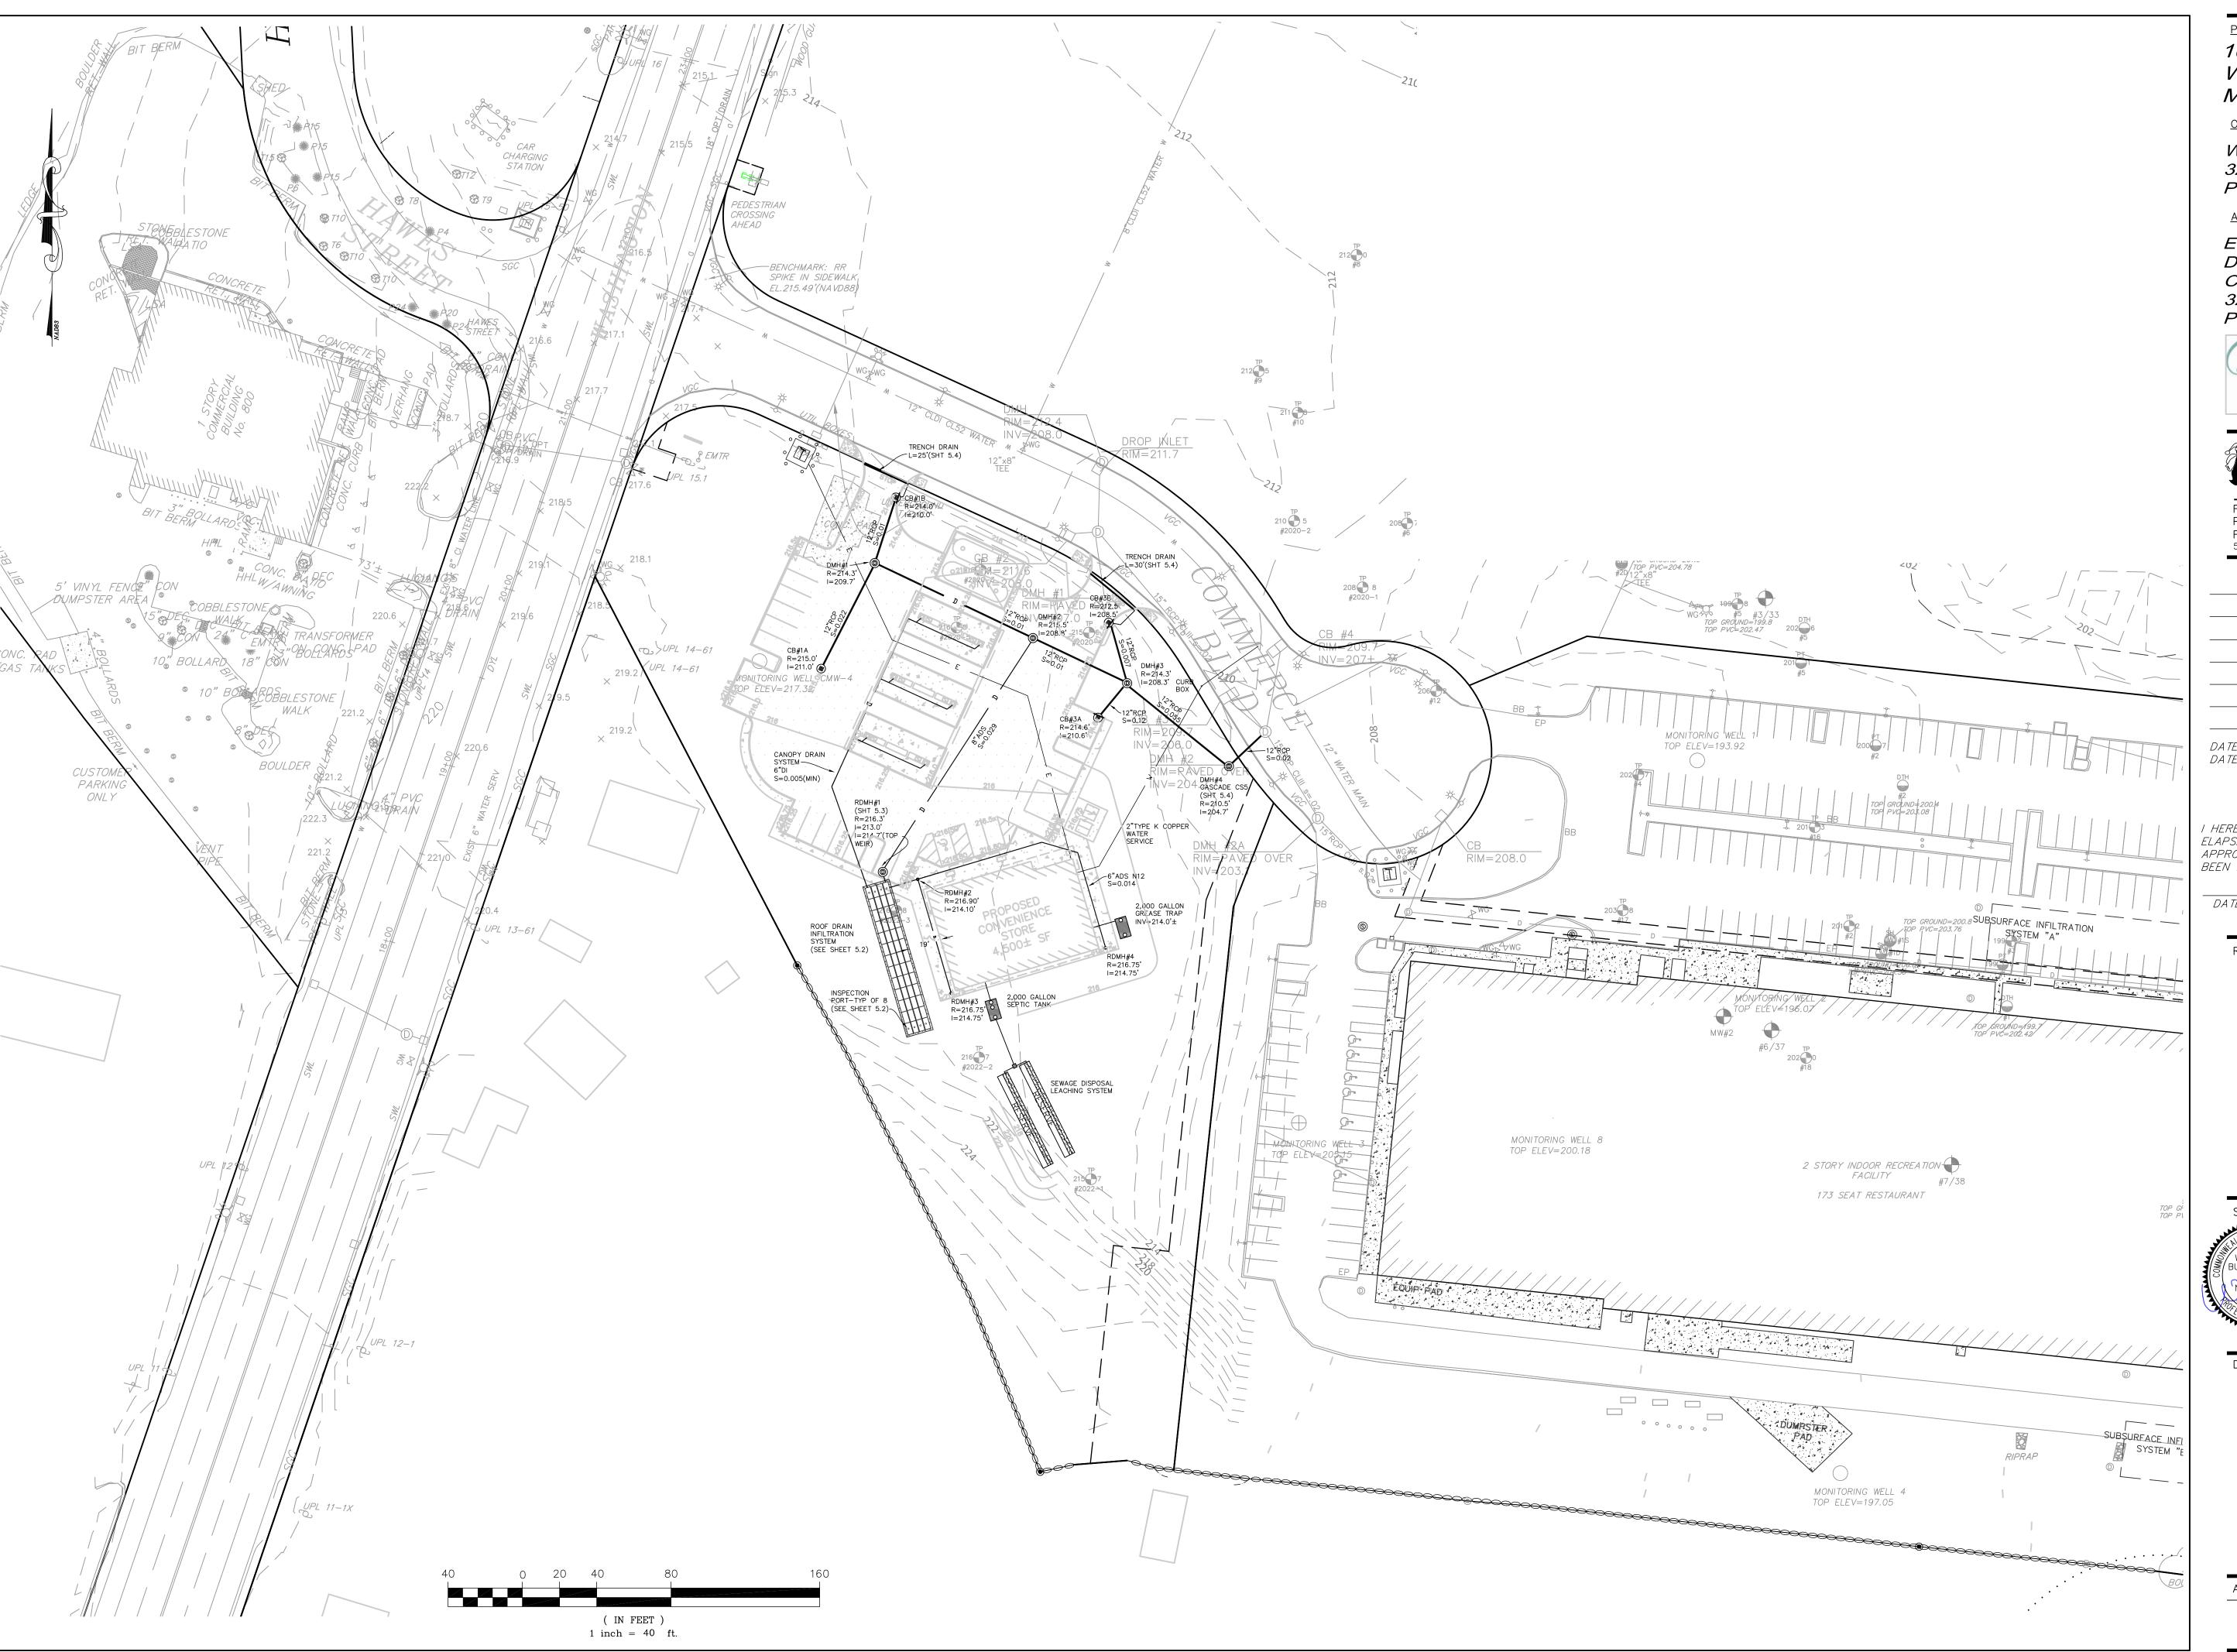

10 Commerce Blvd Wrentham, Massachusetts

OWNER:

WBH, LLC 320 SOUTH STREET PLAINVILLE, MA 02762

<u>APPLICANT:</u>

EDGEWOOD DEVELOPMENT COMPANY 320 SOUTH STREET PLAINVILLE, MA 02762





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REFERENCES



DRAWING TITLE


UTILITY &
DRAINAGE
PLAN


SCALE: 1"=40'

21-0219F


APRIL 19, 2023 SHEET NUMB

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VERTICAL GRANITE CURBING

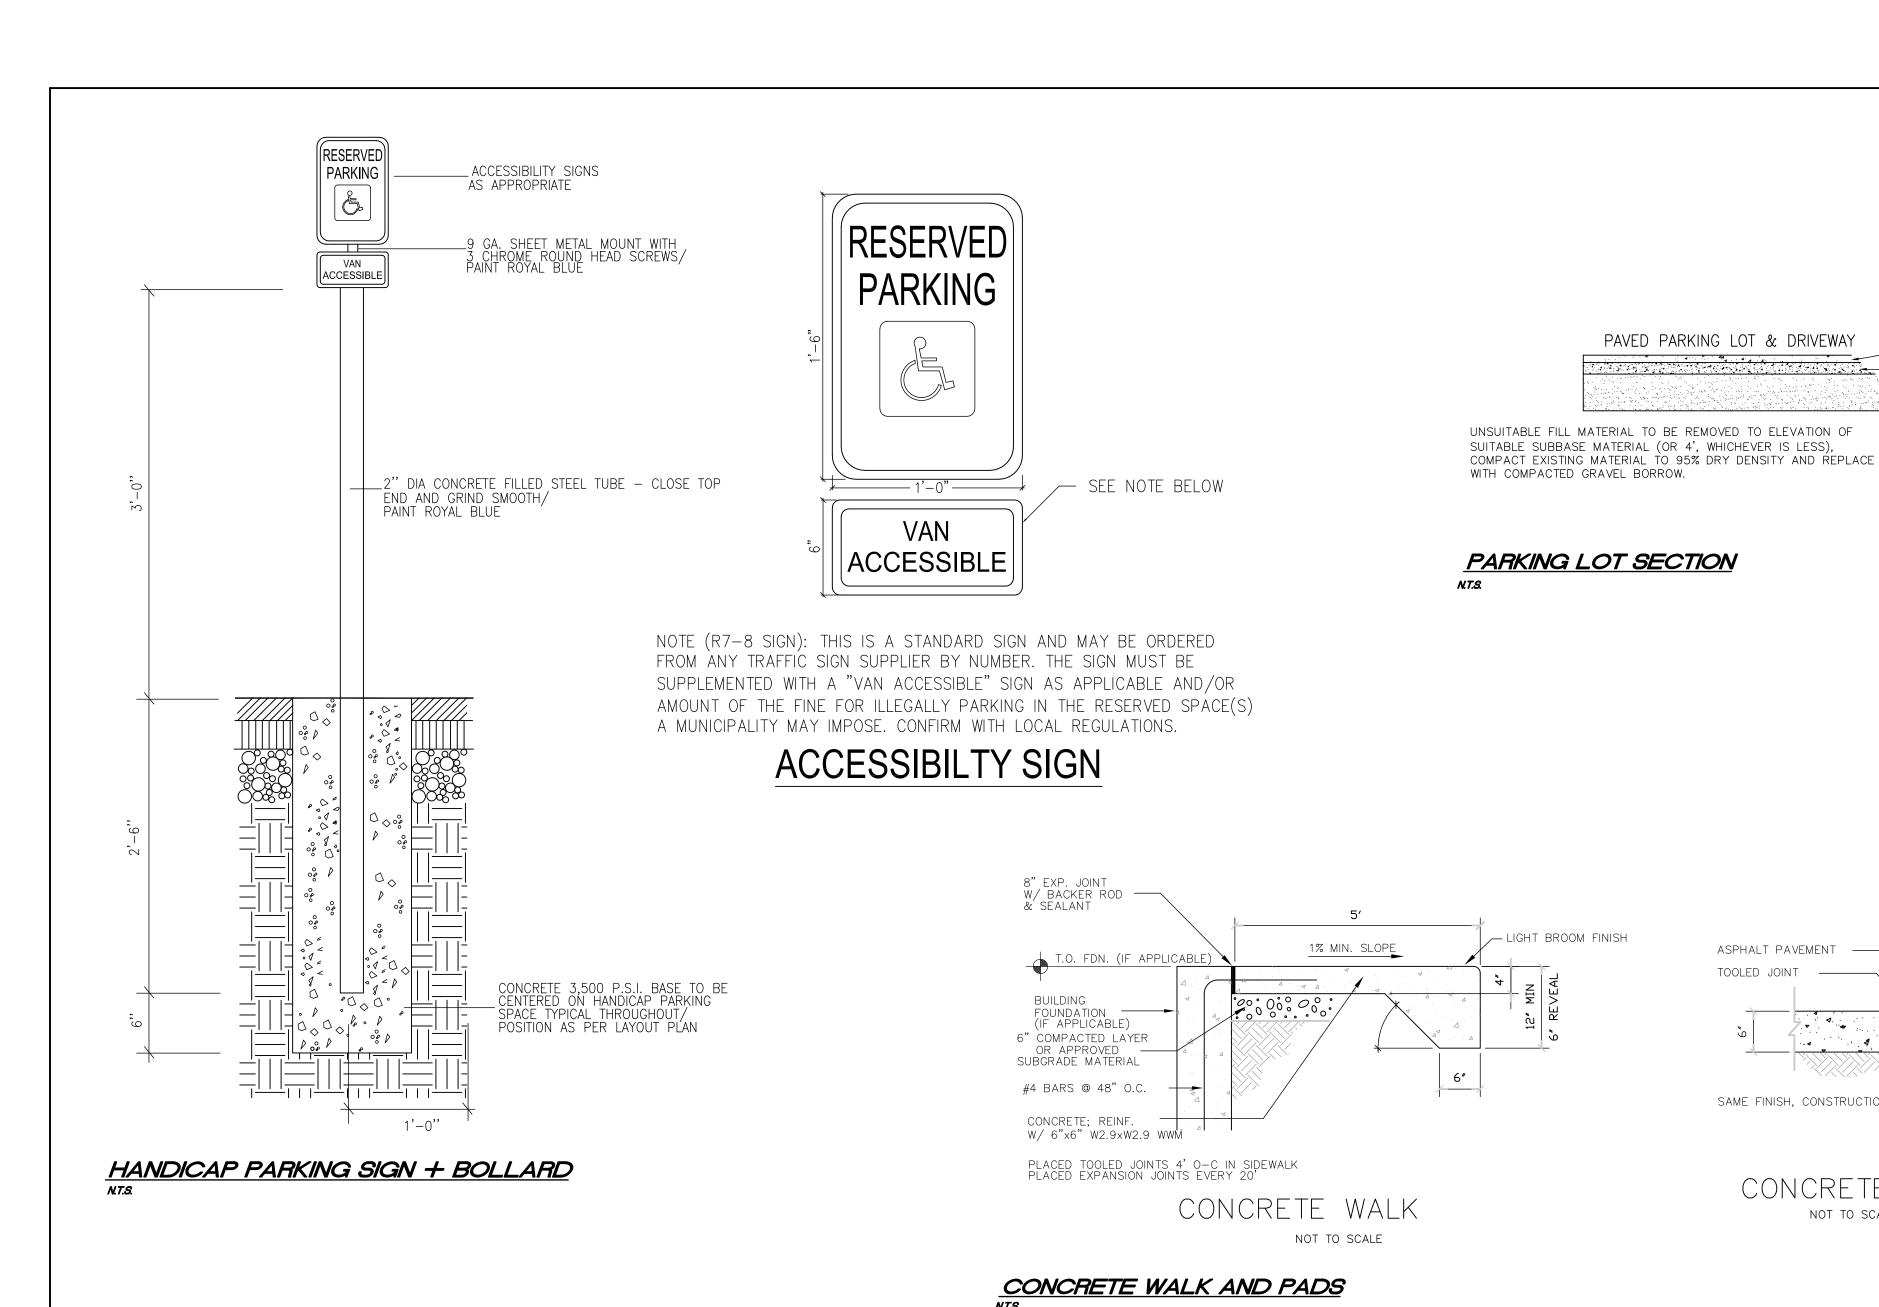

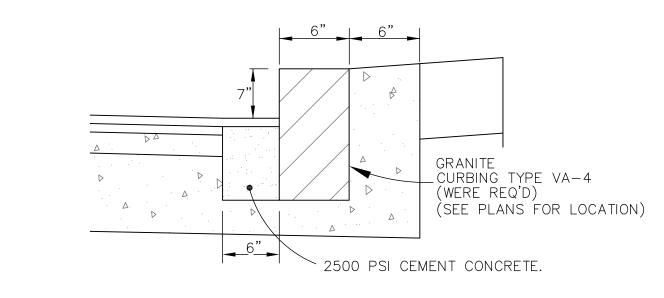VERTICAL CONCRETE CURBING AND DRIVEWAY/PARKING LOT SECTION

- 8"ø STEEL PIPE (DUMPSTER) 6"ø STEEL PIPE (OTHER LOCATIONS) FILL SOLID W/CONCRETE W/WHITE BOLLARD COVER / FINISH GRADE CONCRETE 1. ALL CONCRETE TO BE 3000 PSI. 2. SEE SITE & PARKING PLANS FOR LOCATION. - 16"ø MINIMUM DUMPSTER 12"Ø MINIMUM OTHER LOCATIONS

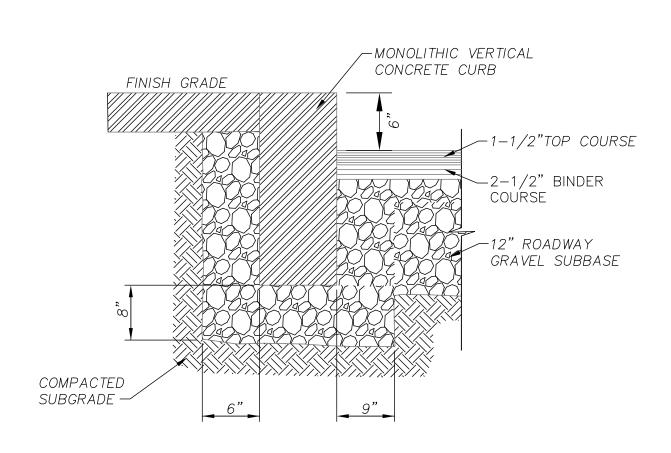BOLLARD DETAIL


ROAD PROFILE GRADE — %	*HIGH SIDE TRANSITION LENGTH
0	6'-6"
>0 ⇒1	7'-8"
>1 ⇒2	9'
>2 =>3	11'


 $>3 \Longrightarrow 4$

CURB TRANSITION LENGTHS FOR WHEELCHAIR RAMPS

15' MAX *BASED ON A DESIGN SLOPE OF 7.5% AND A REVEAL OF 6"

14'

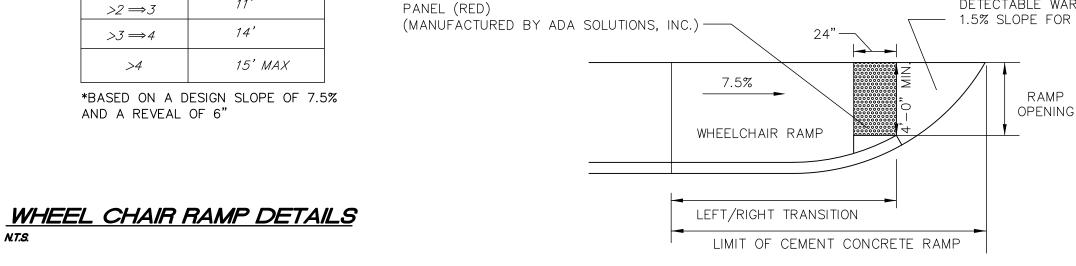

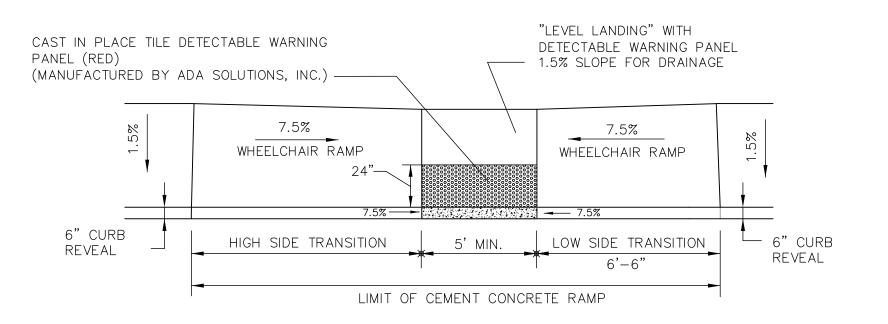

PAVED PARKING LOT & DRIVEWAY

ASPHALT PAVEMENT ----

SAME FINISH, CONSTRUCTION & REINFORCEMENT

CONCRETE PAD


NOT TO SCALE

TOOLED JOINT ---

—— 2-1/2" BINDER COURSE

12" GRAVEL BORROW PLACED

& COMPACTED IN 6" LAYERS

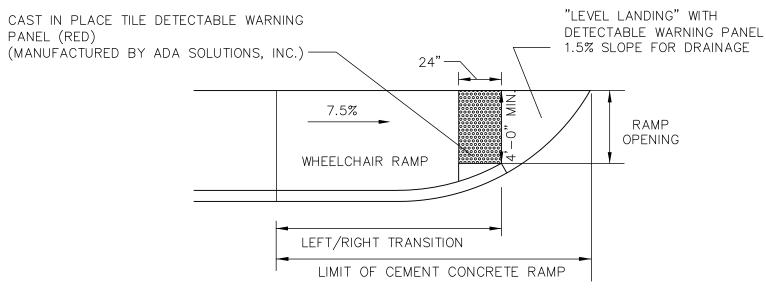

PROJECT:

10 Commerce Blvd Wrentham, Massachusetts

<u>OWNER:</u>

WBH, LLC 320 SOUTH STREET PLAINVILLE, MA 02762

<u>APPLICANT:</u>

EDGEWOOD DEVELOPMENT COMPANY, LLC 320 SOUTH STREET PLAINVILLE, MA 02762






FOUR SCHOOL STREET P.O. BOX 9136 FOXBOROUGH, MA 02035 508-543-3939

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DATE WRENTHAM TOWN CLERK

DATE	DESCRIPTION
STA	MP




DRAWING TITLE

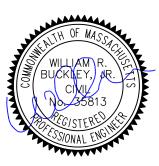Construction Details

SCALE: NTS APRIL 19, 2023

SHEET NUMBER 21-0219F

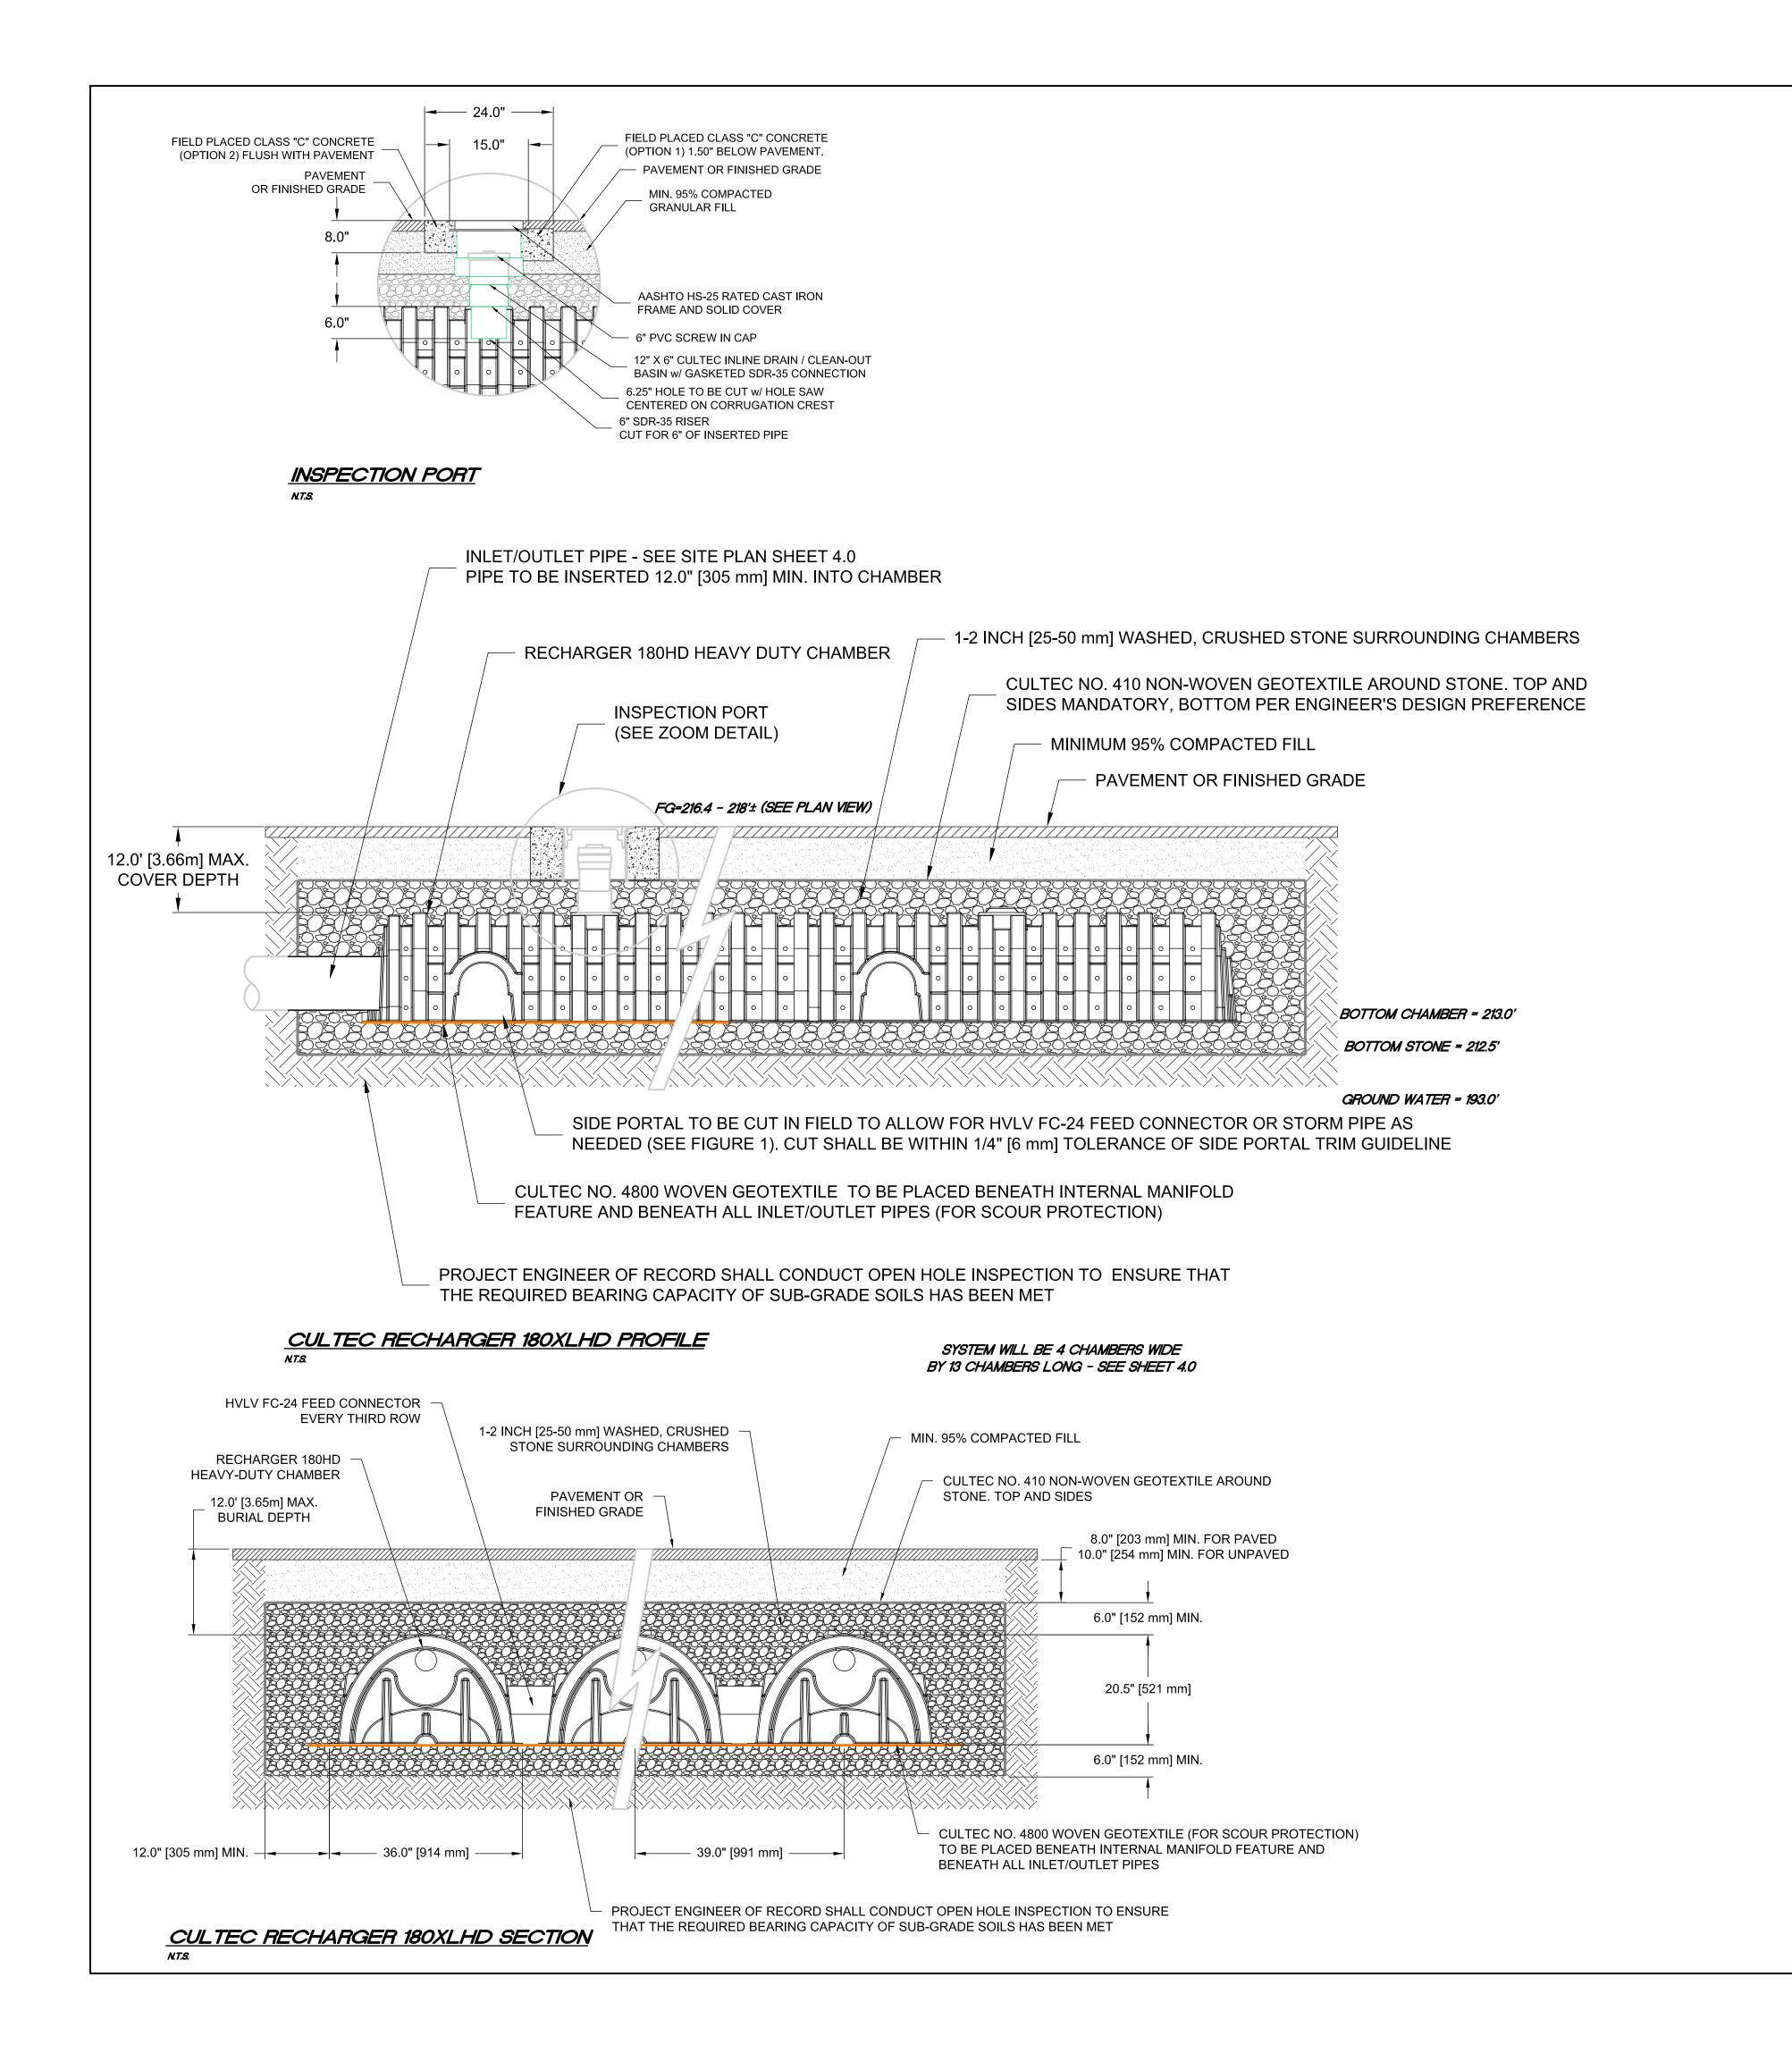

10 Commerce Blvd Wrentham, Massachusetts

OWNER:

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<u>APPLICANT:</u>

EDGEWOOD DEVELOPMENT COMPANY, LLC 320 SOUTH STREET PLAINVILLE, MA 02762






FOUR SCHOOL STREET P.O. BOX 9136 FOXBOROUGH, MA 02035 508-543-3939

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WRENTHAM PLANNING BOARD

DATE WRENTHAM TOWN CLERK



STAMP

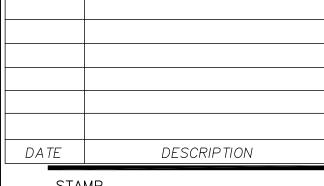

DRAWING TITLE

Construction Details


SCALE: NTS

SHEET NUMBER APRIL 19, 2023

21-0219F

NYLOPLAST 18" DRAIN BASIN: 2818AG _ _ X USE 18" SOLID COVER UNDER PAVEMENT USE 18" PEDESTRIAN IN LANDSCAPING ----COORDINATE WITH LANDSCAPER DURING CONSTRUCTION 18" MIN INTEGRATED DUCTILE IRON WIDTH FRAME & GRATE TO MATCH BASIN O.D. GUIDELINE GRATE OPTIONS LOAD RATING PART # DRAWING # MINIMUM PIPE BURIAL DEPTH PER PIPE VARIABLE INVERT HEIGHTS MANUFACTURER AVAILABLE (ACCORDING TO RECOMMENDATION (5) ADAPTER ANGLES PLANS/TAKE OFF) (MIN. MANUFACTURING REQ. SAME AS MIN. SUMP) VARIABLE 0° - 360° ACCORDING TO PLANS VARIABLE SUMP DEPTH - 12" SUMP FOR CATCH BASIN VARIOUS TYPES OF INLET & OUTLET ADAPTERS AVAILABLE: NO SUMP FOR IN-LINE RISERS 4" - 18" FOR CORRUGATED HDPE (ADS N-12/HANCOR DUAL WALL, ADS/HANCOR SINGLE WALL), N-12 HP, PVC SEWER (EX: SDR 35), PVC DWV (EX: SCH 40), PVC C900/C905, CORRUGATED & RIBBED PVC THE BACKFILL MATERIAL SHALL BE CRUSHED STONE OR OTHER WATERTIGHT JOINT GRANULAR MATERIAL MEETING THE REQUIREMENTS OF CLASS I OR (CORRUGATED HDPE SHOWN) - CLASS II MATERIAL AS DEFINED IN ASTM D2321. BEDDING & BACKFILL FOR SURFACE DRAINAGE INLETS SHALL BE PLACED & COMPACTED UNIFORMLY IN ACCORDANCE WITH ASTM D2321.

NYOPLAST RISER INSTALLATION DETAIL

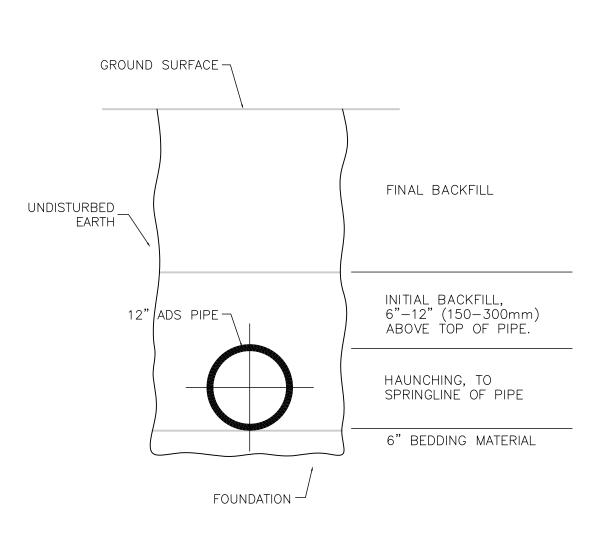

ADS ROOF DRAIN TRENCH DETAIL

1. FOUNDATION: WHERE THE TRENCH BOTTOM IS UNSTABLE, THE CONTRACTOR SHALL EXCAVATE TO A DEPTH REQUIRED BY THE ENGINEER AND REPLACE WITH A FOUNDATION OF CLASS I OR II MATERIAL AS DEFINED IN ASTM D2321, "STANDARD PRACTICE FOR INSTALLATION OF THERMOPLASTIC PIPE FOR SEWERS AND OTHER GRAVITY-FLOW APPLICATIONS," LATEST EDITION; AS AN ALTERNATIVE AND AT THE DISCRETION OF THE ENGINEER, THE TRENCH BOTTOM MAY BE STABILIZED USING A WOVEN GEOTEXTILE FABRIC.

2. <u>BEDDING</u>: SUITABLE MATERIAL SHALL BE CLASS I, II OR III AND INSTALLED AS REQUIRED IN ASTM D2321, LATEST EDITION.


3. HAUNCHING AND INITIAL BACKFILL: SUITABLE MATERIAL SHALL BE CLASS I, II OR III AND INSTALLED AS REQUIRED IN ASTM D2321, LATEST EDITION.

4. UNLESS OTHERWISE SPECIFIED BY THE ENGINEER, MINIMUM TRENCH WIDTHS SHALL BE AS FOLLOWS:

VIIVI O IVI	INCINCII WIDII	13 SHALL DE AS FOLLOWS.
	NOMINAL Ø in (mm)	MIN. RECOMMENDED TRENCH WIDTH, in (mm)
	6 (150) 8 (200) 10 (250) 12 (300) 15 (375) 18 (450) 24 (600)	23 (580) 25 (630) 28 (710) 31 (790) 34 (860) 39 (990) 48 (1220)
OVER F JMMARI	OR VARIOUS LIZED IN THE FOSE NOTED, ALL	UM RECOMMENDED DEPTHS OF IVE LOADING CONDITIONS ARE DLLOWING TABLE. UNLESS DIMENSIONS ARE TAKEN FROM THE GROUND SURFACE.


SURFACE LIVE MINIMUM RECOMMENDED LOADING CONDITION COVER, in (mm) H25 (FLEXIBLE PAVEMENT) 12 (300), 24 (600) FOR 60" (1500) PIPE 12 (300), 24 (600) FOR 60" (1500) PIPE H25 (RIGID PAVEMENT) E80 RAILWAY 24 (600) HEAVY CONSTRUCTION 48 (1200)

*TOP OF PIPE TO BOTTOM OF BITUMINOUS PAVEMENT SECTION

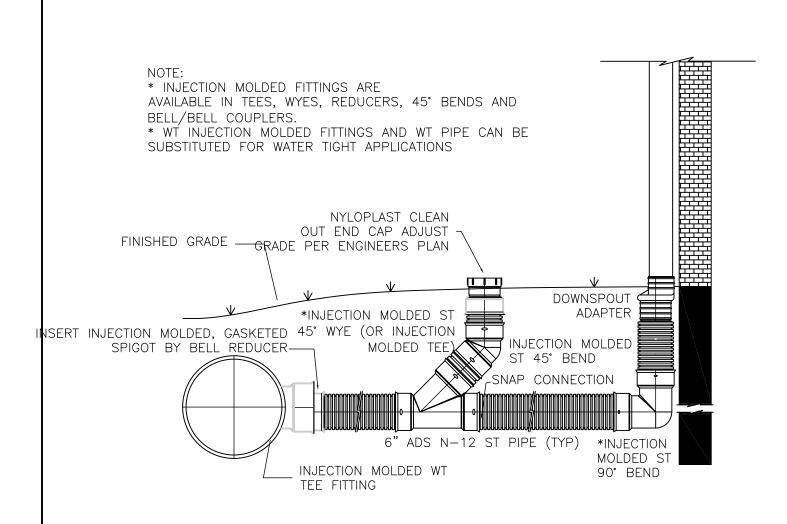



ROOF DRAIN DETAIL WITH CLEANOUT

SET FRAME IN BED OF HIGH EARLY STRENGTH CONCRETE PRIOR TO INSTALLATION OF FINISHED COURSE

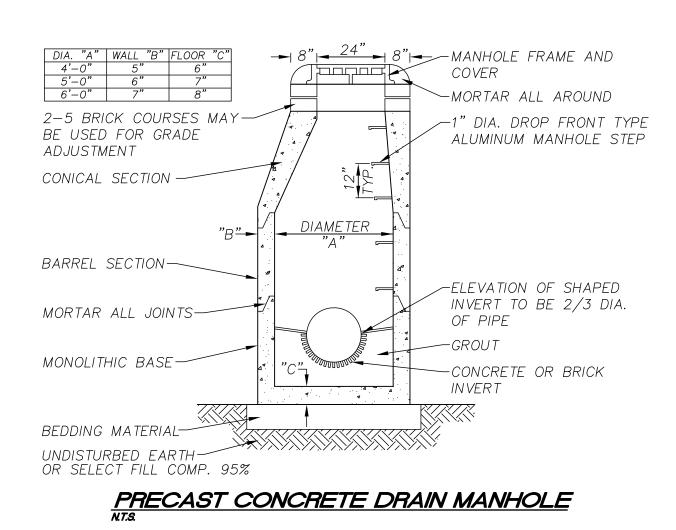

SET FRAME IN BED OF HIGH EARLY STRENGTH CONCRETE PRIOR TO INSTALLATION OF FINISHED COURSE

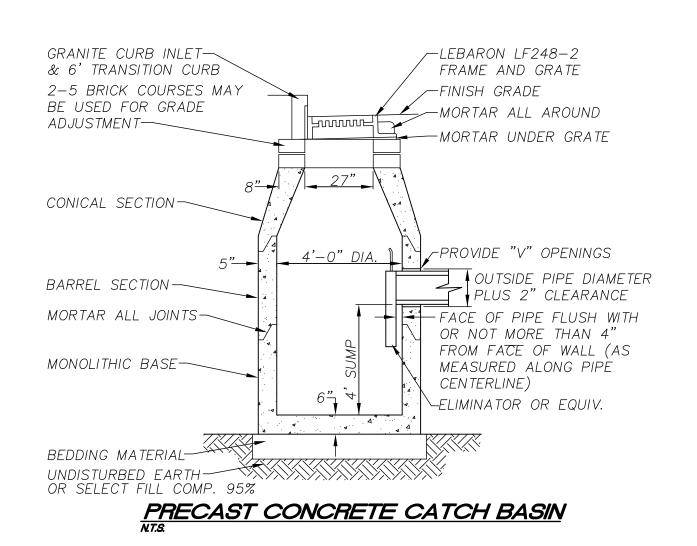

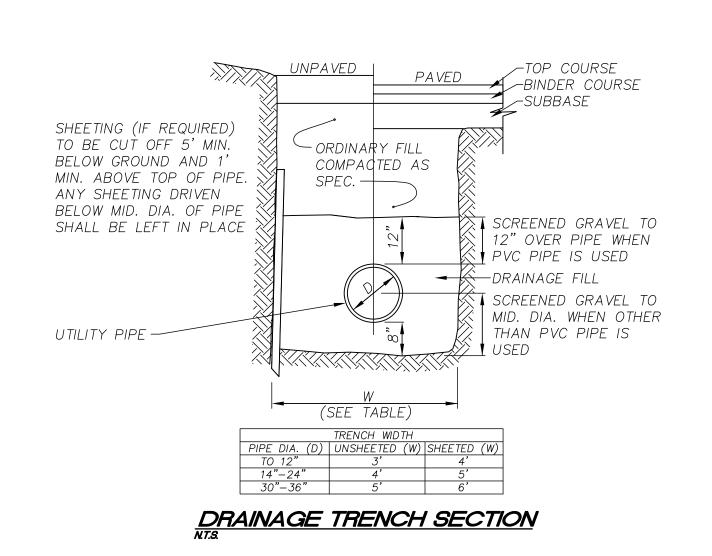

PROJECT:

10 Commerce Blvd Wrentham, Massachusetts

<u>OWNER:</u>

WBH, LLC 320 SOUTH STREET PLAINVILLE, MA 02762

<u>APPLICANT:</u>

EDGEWOOD DEVELOPMENT COMPANY, LLC 320 SOUTH STREET PLAINVILLE, MA 02762






FOUR SCHOOL STREET P.O. BOX 9136 FOXBOROUGH, MA 02035 508-543-3939

DATE APPROVED: _ DATE ENDORSED: _____

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WRENTHAM PLANNING BOARD

DATE WRENTHAM TOWN CLERK



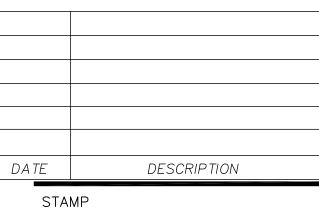

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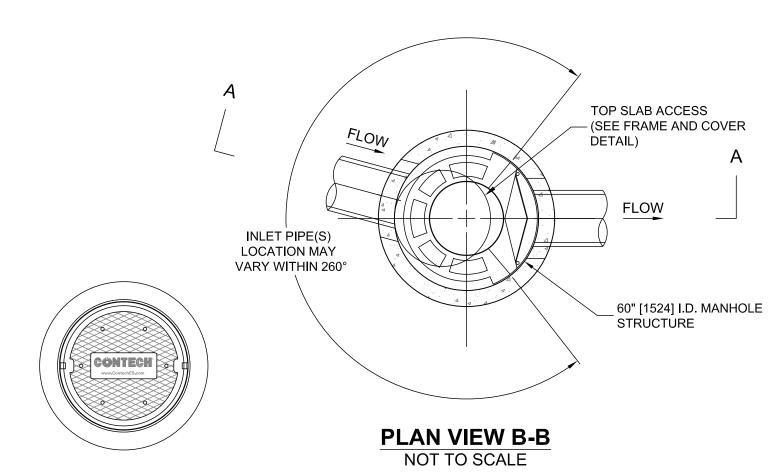
Construction Details

SCALE: NTS SHEET NUMBER APRIL 19, 2023


21-0219F

Table A-1 Cascade SeparatorTM Models and Associated MTFRs 50% Maximum Manhole MTFR **Sediment Storage** Area Volume Diameter CS-3 1.02 5.3 CS-4 9.4 1.80 CS-5 2.81 14.7 CS-6 21.2 CS-8 7.20 37.7 58.9 CS-10 11.3 16.2 CS-12 12 84.8

CASCADE MAXIMUM TREATMENT FLOW RATE (50% TSS REMOVAL) TABLE A-1 NEW JERSEY DEP LAB CERTIFICATION MAY 18, 2020





FRAME AND COVER
(DIAMETER VARIES)
NOT TO SCALE

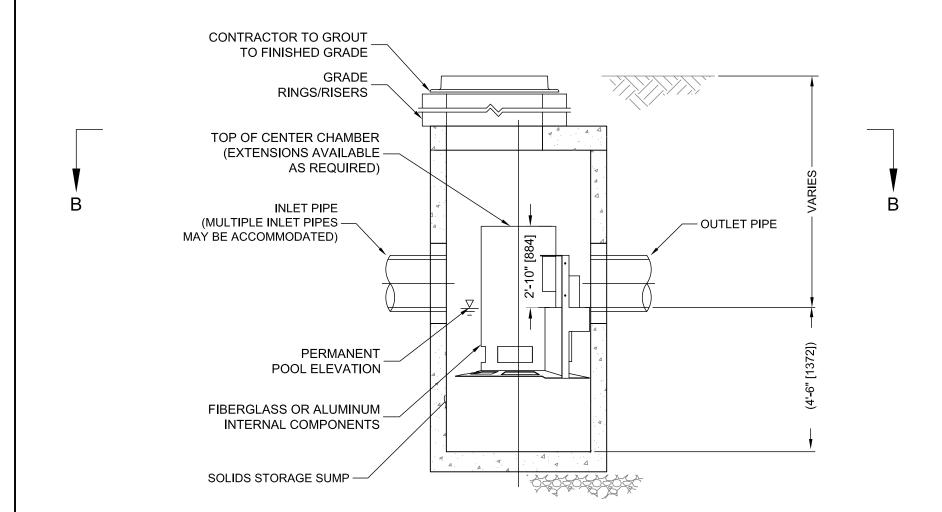

ELEVATION A-A NOT TO SCALE

CONTECH CASCADE CS-5 DETAIL

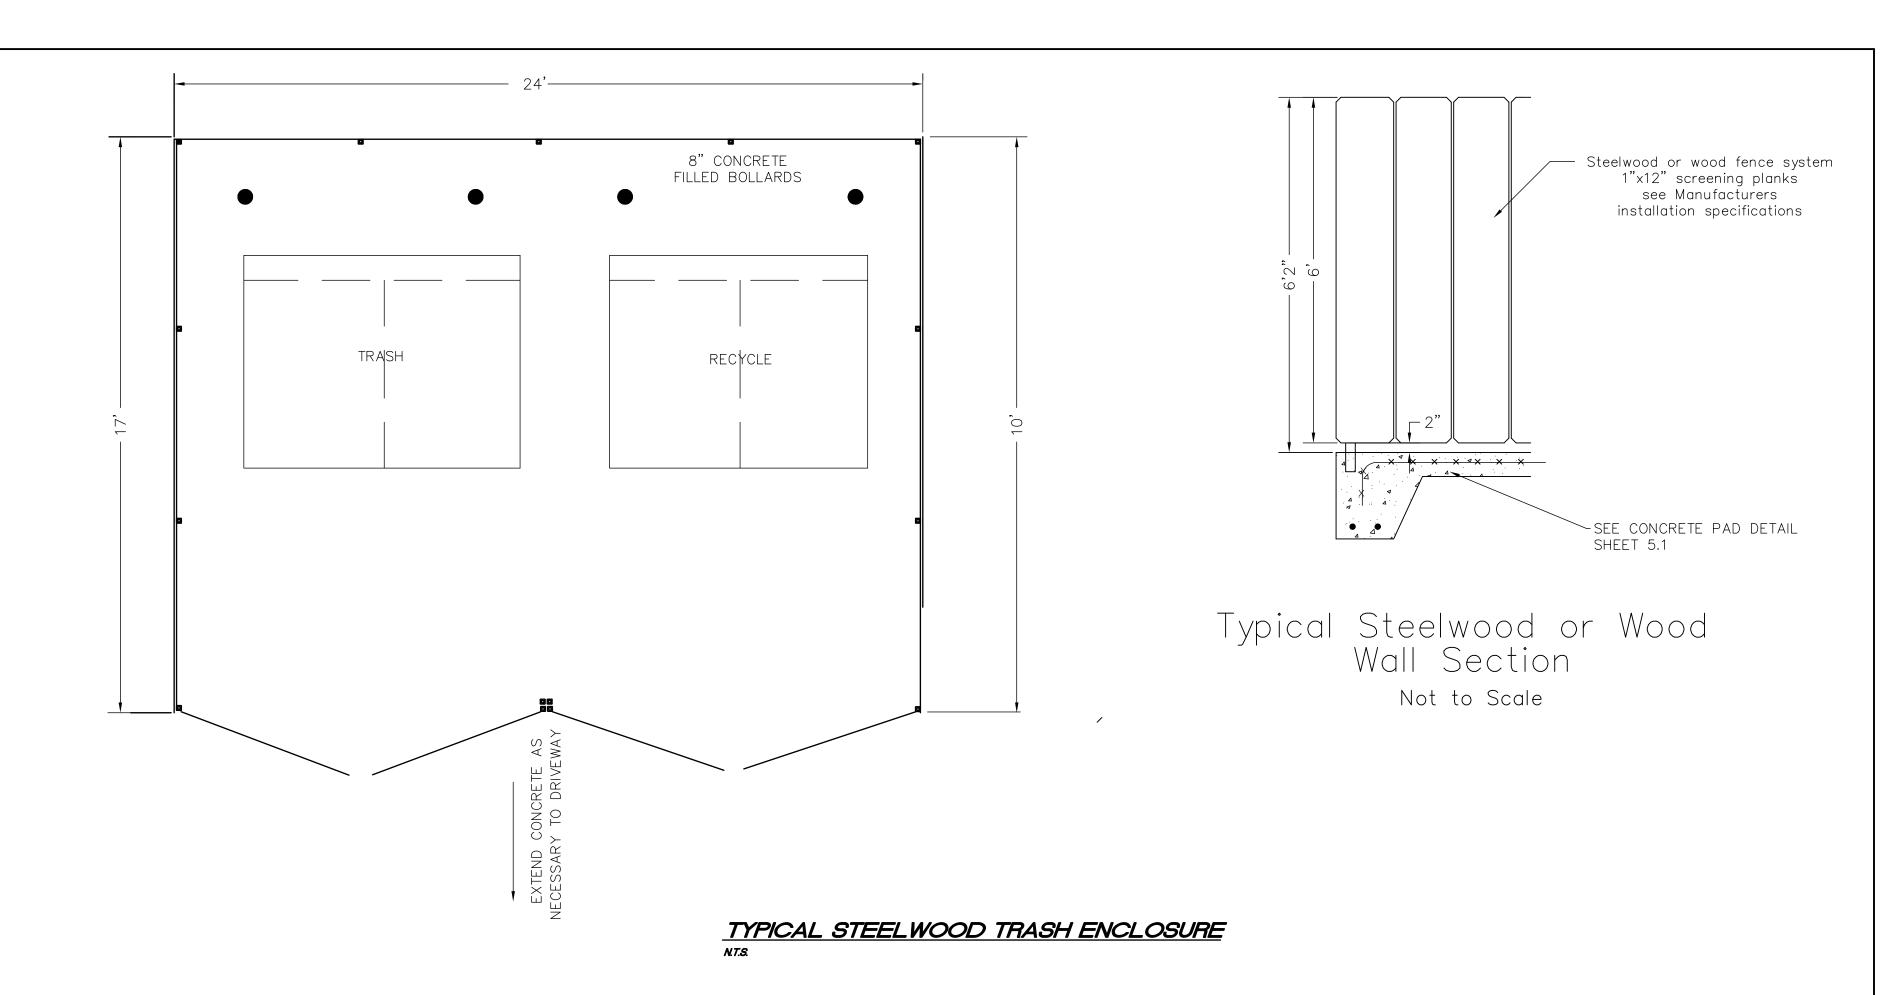

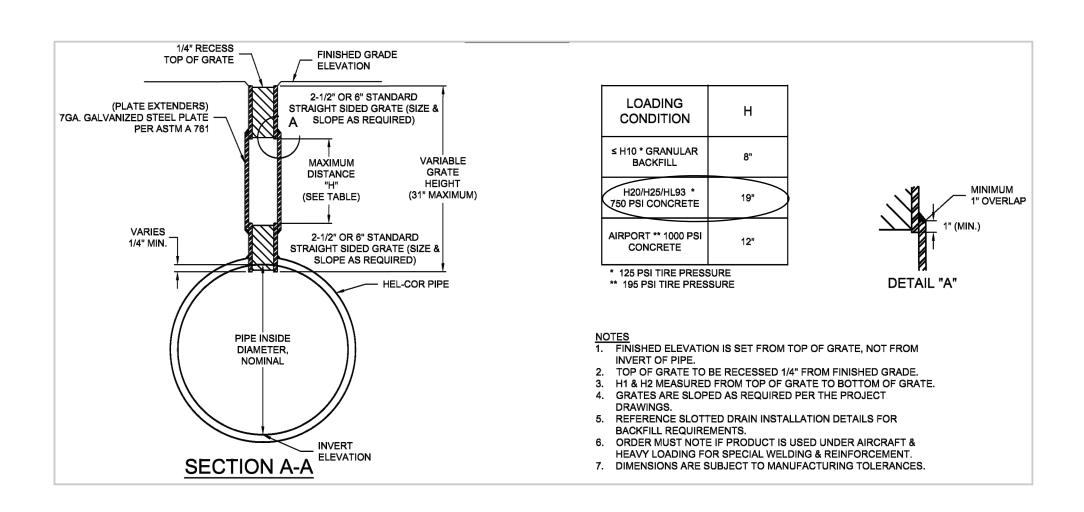

CONTECH SLOTTED DRAIN VARIABLE HEIGHT GRATE

PROJECT:

10 Commerce Blvd Wrentham, Massachusetts

OWNER:

WBH, LLC 320 SOUTH STREET PLAINVILLE, MA 02762

<u>APPLICANT:</u>

EDGEWOOD DEVELOPMENT COMPANY, LLC 320 SOUTH STREET PLAINVILLE, MA 02762





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DATE	DESCRIPTION
STAI	MP




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Construction Details

SCALE: NTS

APRIL 19, 2023 SHEET NUMBE

21-0219F **5.**

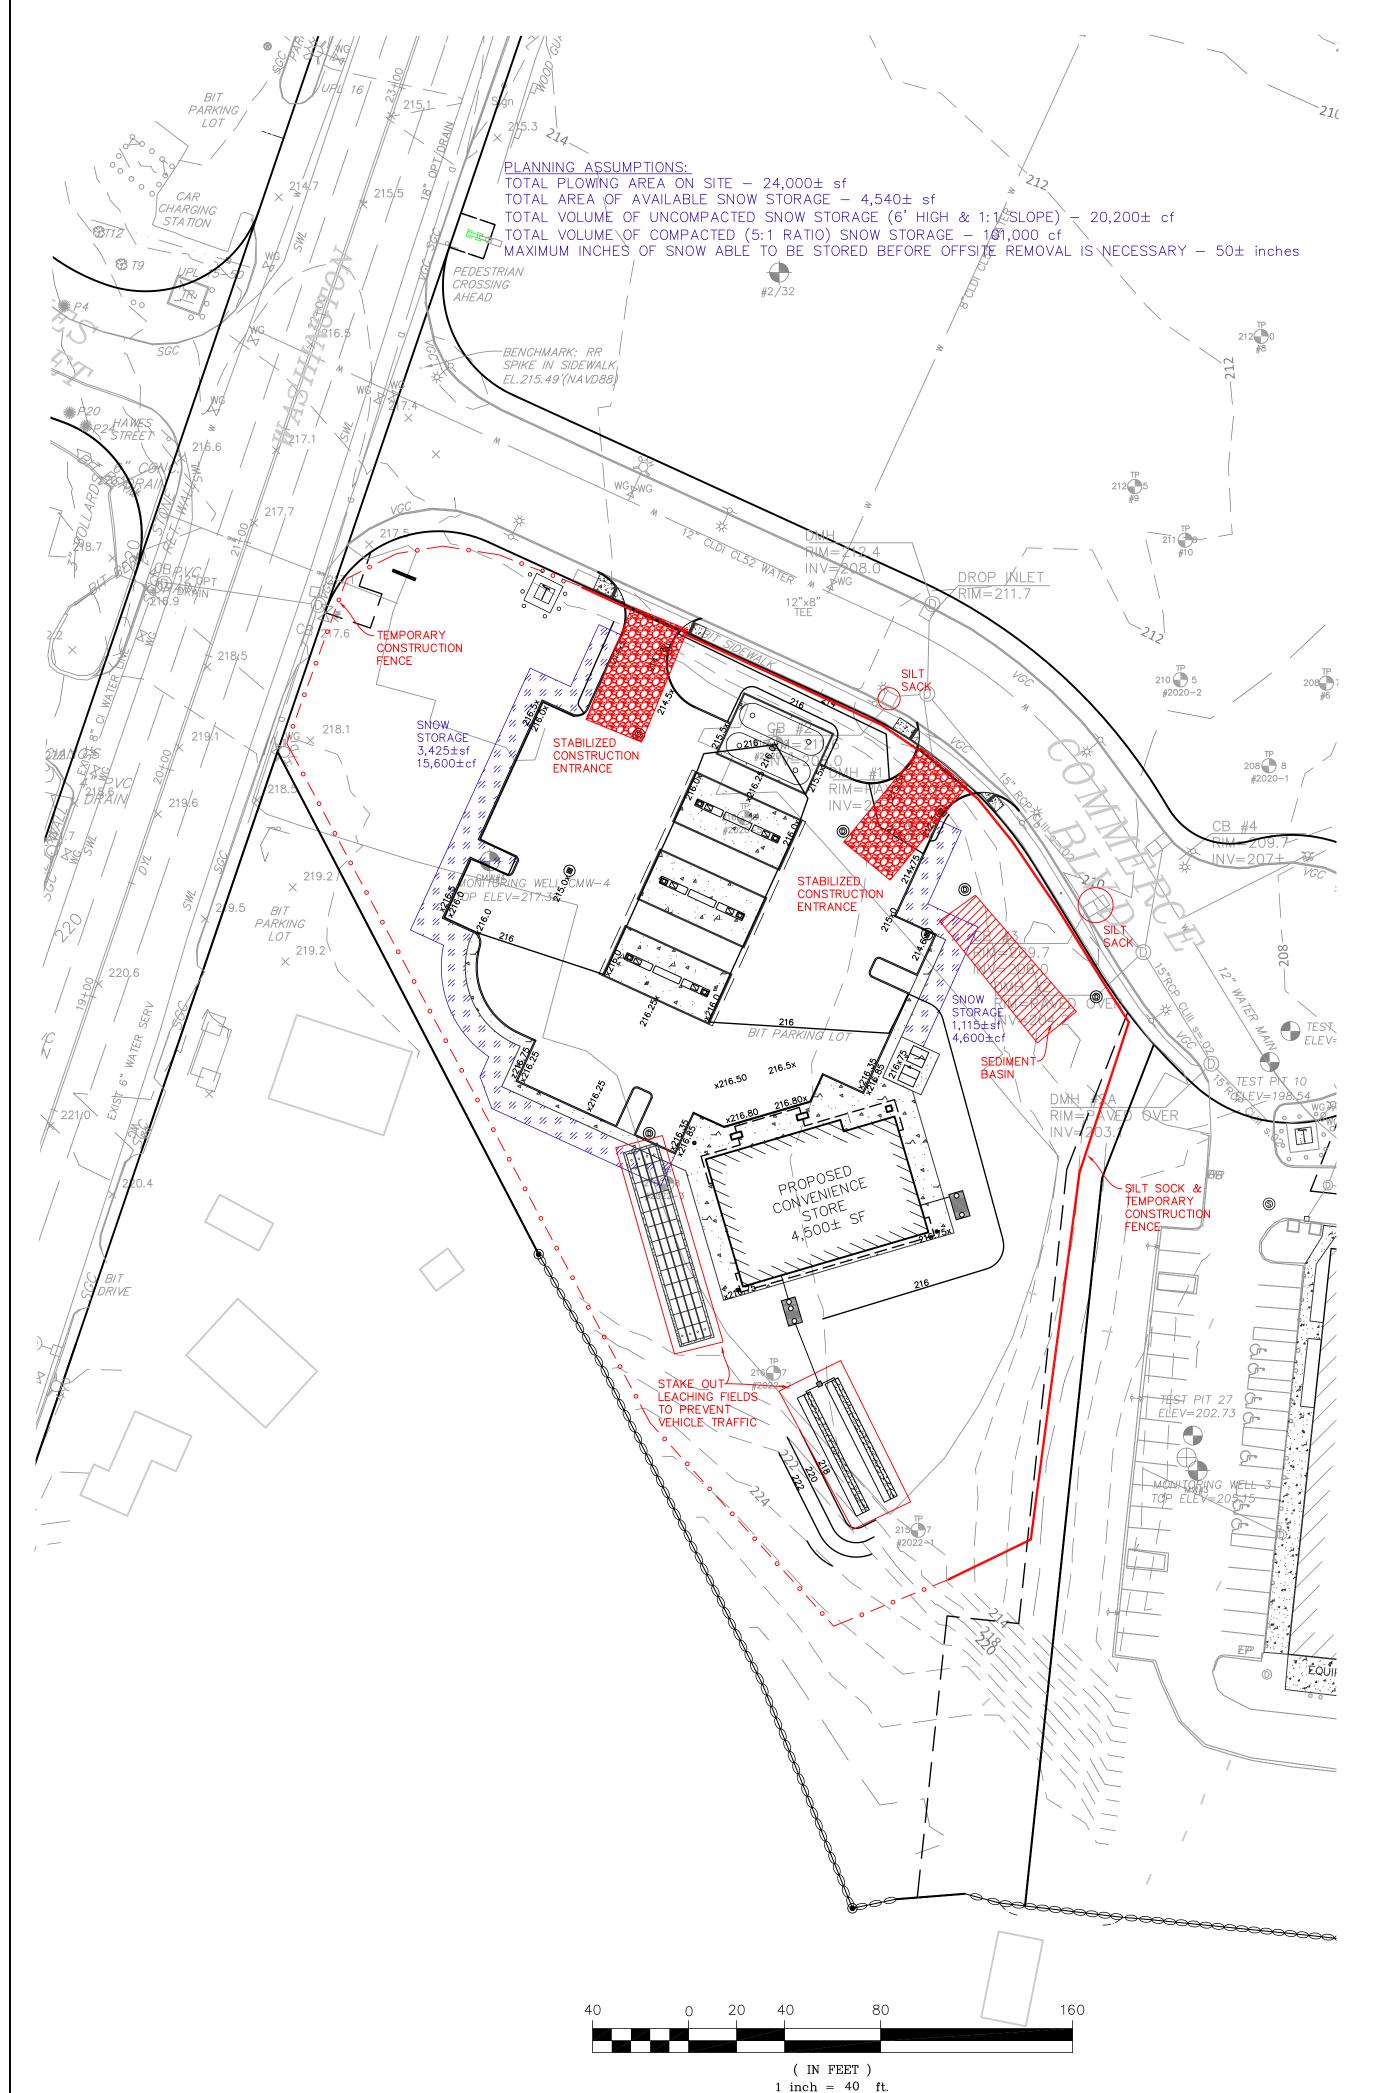

EROSION & SEDIMENT CONTROL BMPs

<u>EXISTING VEGETATION</u> — EXISTING VEGETATION OUTSIDE OF THE LIMIT OF WORK WILL BE PROTECTED BY MULCH FILLED SILT SOCKS OR ORANGE CONSTRUCTION FENCE.

CLEARING AND GRUBBING — CLEARING AND GRUBBING WILL TAKE PLACE AFTER THE PLACEMENT OF THE SILT SOCK AND ORANGE CONSTRUCTION FENCE. CUT TREES SHALL BE STAGED AT LEAST 100' FROM ANY WETLAND RESOURCE AREA. STUMPS SHALL NOT BE BURIED AND SHALL BE REMOVED FROM THE SITE. STUMPS SHALL BE PLACED IN DUMPSTERS OR STOCKPILED AT LEAST 100' FROM ANY WETLAND RESOURCE AREA.

SOIL STABILIZATION — IMMEDIATELY UPON COMPLETION OF ROUGH GRADING THE SLOPES ON THE SOUTH AND EAST SIDES OF THE PROPERTY SHALL BE PLANTED WITH "MHD MIXTURE FOR SLOPES AND SHOULDERS — MHD SPECIFICATION M6.03.0" AND COVERED WITH EROSION CONTROL MATTING (ECS—2B BY NEW ENGLAND WETLAND PLANTS OR EQUIV) INSTALLED IAW MANUFACTURER'S RECOMMENDATION. THE PURPOSE IS TO CONTROL EROSION AND SEDIMENTATION UNTIL THE SITE IS STABILIZED. STAKE AREA OF PROPOSED SEPTIC SYSTEM AND UNDERGROUND INFILTRATION SYSTEM SO THAT VEHICLES DO NOT COMPACT THE SOILS. HYDROSEEDING CONSISTING OF WOOD FIBERS, FERTILIZER AND STABILIZING EMULSION SHALL TAKE PLACE IN SLOPED AREAS OF EXPOSED SOILS WHERE CONSTRUCTION WILL CEASE FOR MORE THAN 14 DAYS.

TEMPORARY SEDIMENT BASINS — GRADING, AND DIVERSION SWALES IF NECESSARY, SHALL BE USED THROUGHOUT THE SITE IN ORDER TO DIRECT RUNOFF TO THE TEMPORARY SEDIMENT BASIN LOCATED IN THE NE CORNER OF THE SITE IN ORDER TO CAPTURE RUNOFF AS CLOSE TO THE SOURCE AS PRACTICAL TO PREVENT IT FROM MIGRATING OUTSIDE OF THE LIMIT OF WORK. THE OVERFLOW OF THE SEDIMENT BASIN SHALL BE DIRECTED TOWARD EXISTING CB#3 IN COMMERCE BLVD.

SILT SOCKS — SHALL BE USED ON THE PROJECT AT THE LIMIT OF WORK ALONG COMMERCE BLVD AND THE EAST PROPERTY LINE. THEY SHALL BE 12" DIAMETER AND MULCH FILLED IN ACCORDANCE WITH THE WRENTHAM CONSERVATION COMMISSION'S SPECIFICATIONS FOR MULCH FILTER TUBES. HAY BALES AND STRAW WATTLES ARE NOT ACCEPTABLE. INSPECT AFTER EACH RAINFALL AND ANY GAPS, OVERTOPPING, CLOGGING, EROSION, SEDIMENT TO HALF THE HEIGHT, OR OTHERWISE BECOME INEFFECTIVE SHALL BE IMMEDIATELY REMEDIED. THE LOCATIONS OF THE SOCKS SHALL CHANGE BASED ON THE PHASES OF CONSTRUCTION AND OTHER SITE CONDITIONS, BUT THE REQUIREMENT IS THAT THEY SHALL PREVENT SEDIMENT FROM EXITING THE LIMIT OF WORK. AFTER SITE IS STABILIZED THE THE EXTERIOR TUBING MATERIAL SHALL BE CUT AND REMOVED OFF SITE AND THE FILTER MATERIAL SHALL BE RAKED INTO NO GREATER THAN 3" DEPTH.

SILT SACKS — SHALL BE PLACED IN ALL CATCH BASINS ON THE PROJECT AND ON COMMERCE BOULEVARD AND SHALL REMAIN UNTIL THE SITE HAS BEEN FULLY STABILIZED. THE SACKS SHALL BE CHECKED AND CLEANED AFTER EVERY STORM AND IF MORE THAN ½ FULL.

MATERIAL PILES — ALL MATERIAL PILES SHALL BE PLACED MORE THAN 100' FROM ANY WETLAND RESOURCE AREAS. THEY SHALL BE ENCIRCLED WITH A SILT SOCK AND CONSTRUCTION FENCE IAW DETAIL ON SHEET 6.2.

STABILIZED CONSTRUCTION ENTRANCES — SHALL BE PLACED AT THE START OF CONSTRUCTION ON COMMERCE BLVD WHERE THE FINAL DRIVEWAYS ARE TO BE LOCATED. THEY ARE TO BE USED FOR ACCESS AND EGRESS. NO ACCESS FROM ROUTE ONE IS ALLOWED. THEY SHALL BE INSPECTED WEEKLY AND THE AGGREGATE SHALL BE REPLENISHED OR REPLACED AS NECESSARY TO ENSURE NO SEDIMENT IS ON COMMERCE BLVD. IF SEDIMENT IS DEPOSITED ON THE STREET THE CONTRACTOR SHALL HAVE IT SWEPT UP BY THE END OF THE WORK DAY.

PROCEDURAL NOTES

1. PRIOR TO ANY ALTERATION OF THE SITE, AN ON-SITE MEETING BETWEEN THE OWNER'S REPRESENTATIVE, THE CONSTRUCTION SUPERVISOR, AND THE CONSERVATION AGENT SHALL OCCUR. THE OWNER AND AGENT MAY INVITE OTHER INDIVIDUALS NEEDED. SIMILAR MEETINGS WILL OCCUR ONCE EROSION CONTROL MEASURES ARE IN PLACE AND THEREAFTER ON A MONTHLY BASIS UNLESS OTHERWISE AGREED TO BY ALL PARTIES.

2. THE INSPECTION OF EROSION CONTROL DEVICES WILL BE DONE BY THE APPLICANT'S ENGINEER, AND ONCE DETERMINED TO BE ACCURATE, THE ENGINEER WILL SEND A LETTER TO THE CONSERVATION COMMISSION ATTESTING TO THE ACCURACY AND DESCRIBING ANY DEVIATIONS.

3. THE PROJECT CONSTRUCTION SUPERVISOR WILL INSPECT THE SITE EROSION CONTROLS IAW THE SWPPP PLAN AND O&M PLAN. THE OWNER SHALL SUBMIT ANY CHANGES TO SEQUENCE OR TIMING OF CONSTRUCTION OR INSPECTIONS TO THE COMMISSION PRIOR TO IMPLEMENTATION.

4. INSTALL A LIMIT OF WORK (LOW) FENCE TO ENCLOSE THE WORK SITE.
5. STORM WATER MUST BE MANAGED IN THE WORK AREA AND NOT DISCHARGED OUTSIDE OF SAME.
6. ALL BARE SOIL WITHIN THE SITE POTENTIALLY DRAINING TO A PROPOSED

INFILTRATION PRACTICE OR OFF THE SITE SHALL BE STABILIZED WITHIN 48 HOURS AND NO SEDIMENT IS TO LEAVE THE LIMIT OF WORK.

7. IF FEASIBLE, A STUMP GRINDER SHALL BE USED TO MAKE MULCH MATERIAL THAT CAN BE STOCKPILED AND USED THROUGHOUT THE SITE FOR STABILIZATION

ALONG WITH LEAVES AND OTHER SURFACE DEBRIS.

8. NO TOPSOIL IS TO BE IMPORTED TO THE SITE UNLESS REQUIRED BECAUSE OF TOPSOIL GATHERED OR STOCKPILED ON THE SITE, AND ONLY IF PRE—APPROVED BY THE WRENTHAM CONSERVATION AGENT.

LEGEND

SILT SOCK SILT SACK

 \bigcirc

ALONG THE LIMIT OF WORK LINES WHERE SILT SOCKS ARE <u>NOT</u> SPECIFIED THE CONTRACTOR SHALL MARK THE LIMIT OF WORK WITH ORANGE CONSTRUCTION FENCING.

PROJECT PHASING

PHASE 1: EST. START DATE: EST. FINISH DATE:

INSTALL EROSION CONTROLS AND LIMITS OF WORK, CLEAR TREES TO LIMIT OF WORK, GRUBBING AND REMOVAL OF STUMPS FROM SITE. INSTALLATION OF TEMPORARY SEDIMENT BASINS.

PHASE 2: EST. START DATE: EST. FINISH DATE:

IMPORT AND PLACEMENT OF MATERIAL TO BRING PARKING AREAS AND BUILDING TO SUBGRADE. CONSTRUCTION OF BUILDING FOOTINGS AND FOUNDATIONS.

PHASE 3: EST. START DATE:

EST. FINISH DATE: _

INSTALLATION OF DRAINAGE AND UTILITIES. CONSTRUCTION OF STORM WATER BASIN.
CONTINUE CONSTRUCTION OF BUILDING. BASE COURSE OF PAVEMENT.

PHASE 4:
EST. START DATE:
EST. FINISH DATE:

COMPLETE CONSTRUCTION OF BUILDING. INSTALL SIDEWALKS AND FINISHED COURSE OF PAVEMENT. COMPLETE LANDSCAPING OF DISTURBED AREAS. REMOVE EROSION CONTROLS ONCE SITE IS FULLY STABILIZED.

PROJECT:

10 Commerce Blvd Wrentham, Massachusetts

<u>OWNER:</u>

WBH, LLC 320 SOUTH STREET PLAINVILLE, MA 02762

APPLICANT:

EDGEWOOD DEVELOPMENT COMPANY, LLC 320 SOUTH STREET PLAINVILLE, MA 02762





FOUR SCHOOL STREET P.O. BOX 9136 FOXBOROUGH, MA 02035 508-543-3939

WRENTHAM PLANNING BOARD

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REFERENCES



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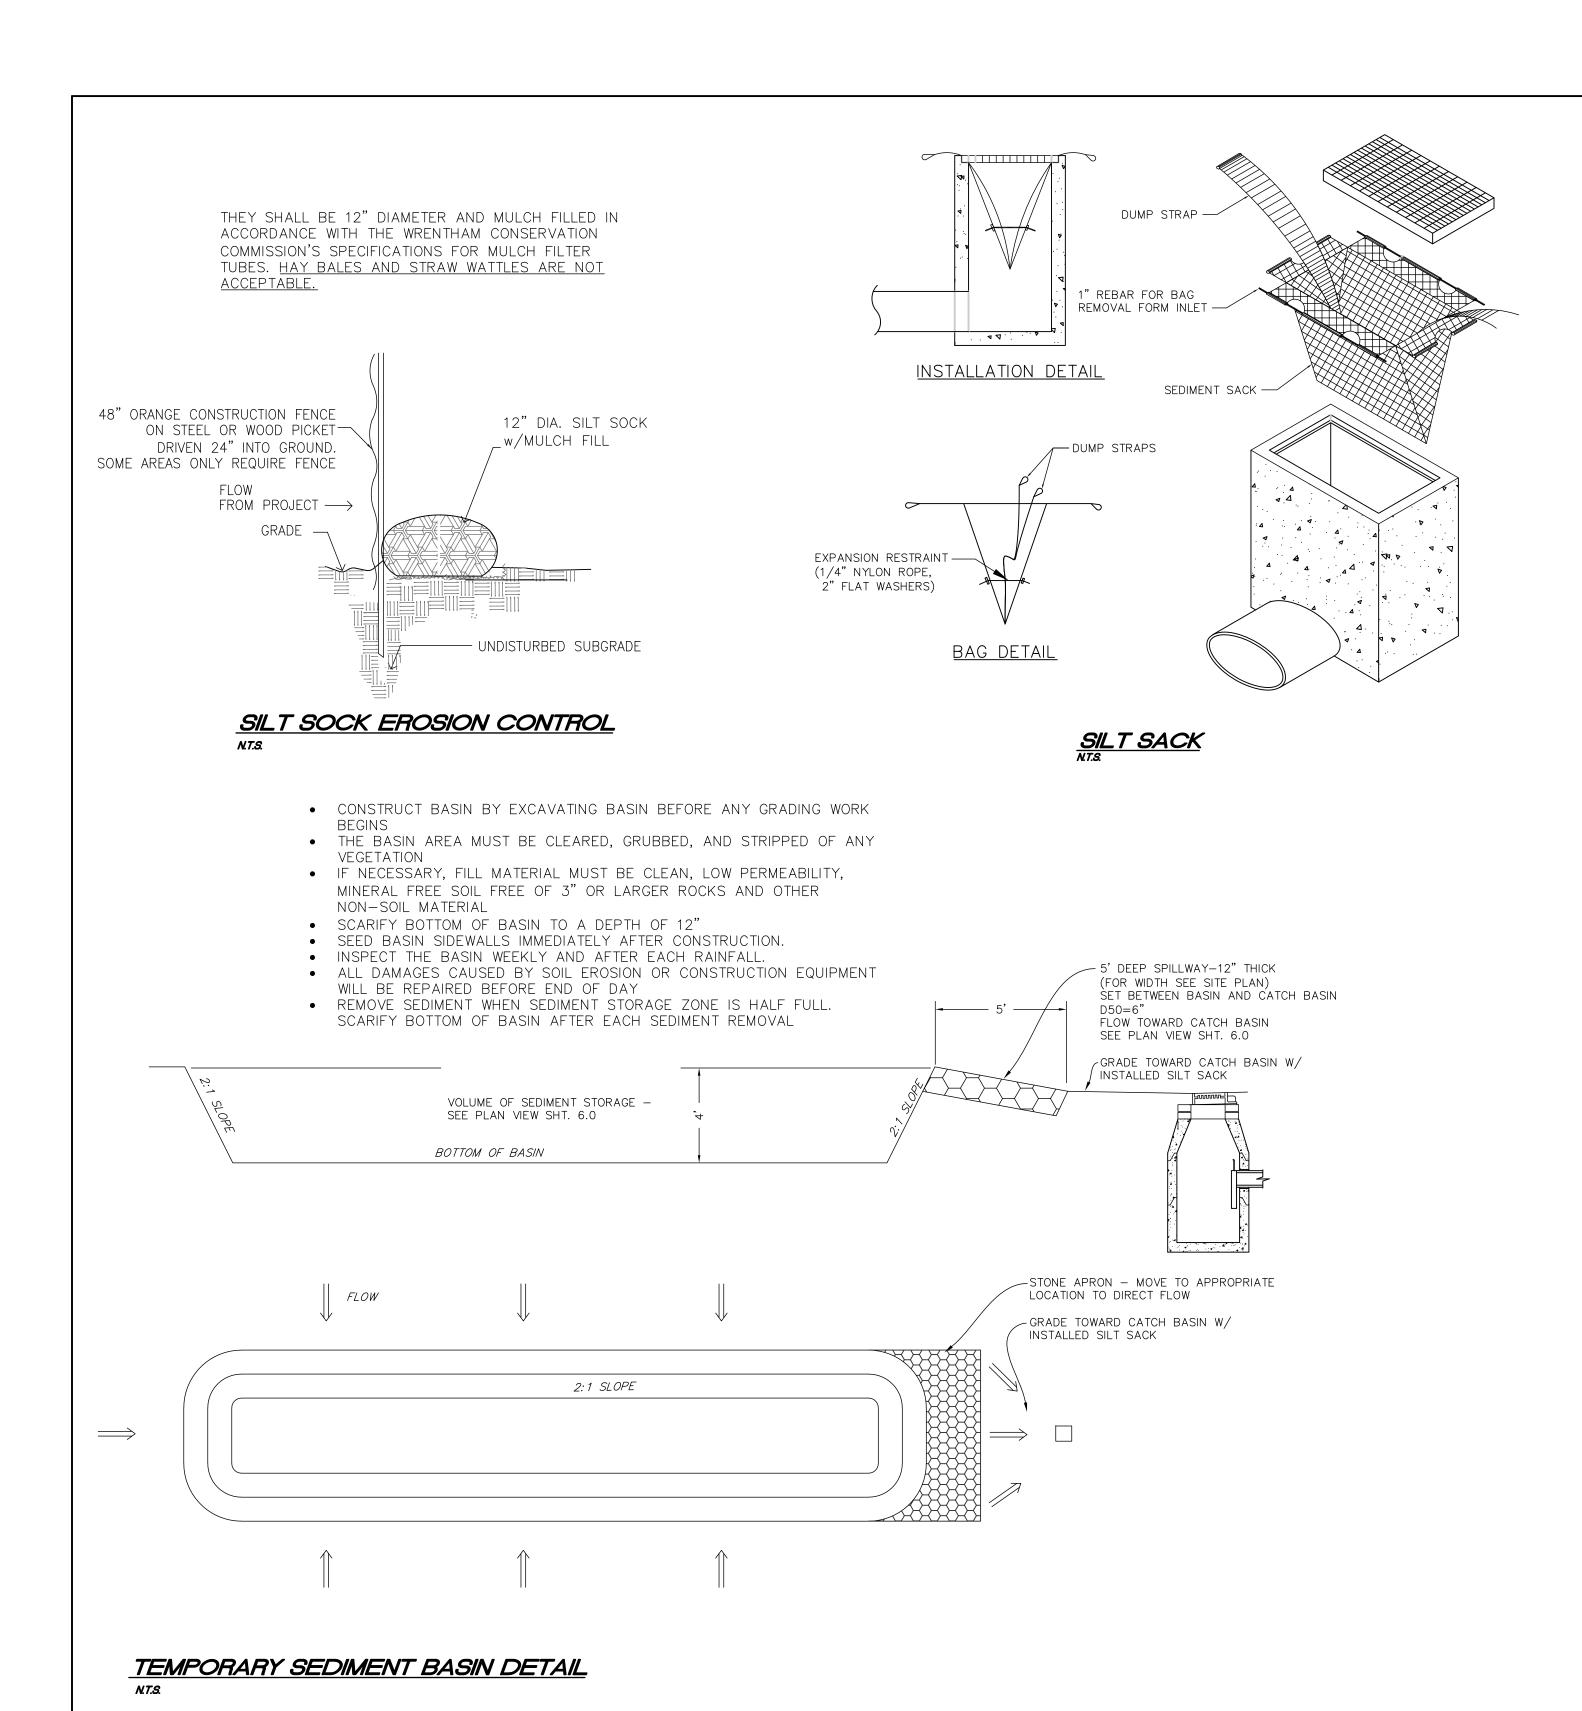
SWPPP & SNOW STORAGE PLAN


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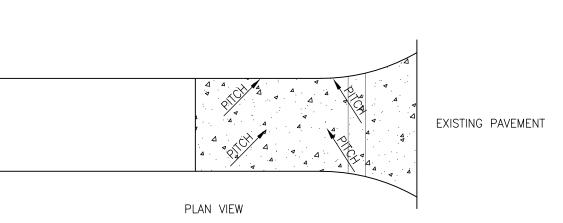
APRIL 19, 2023 SHEET NUMBER

21-0219A

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STABILIZED CONSTRUCTION ENTRANCE

THE SITE SUPERVISOR SHALL BE RESPONSIBLE FOR ENSURING THAT VEHICLES EXITING THE SITE HAVE

MATERIAL COVERS IN PLACE AND THAT VEHICLES ARE

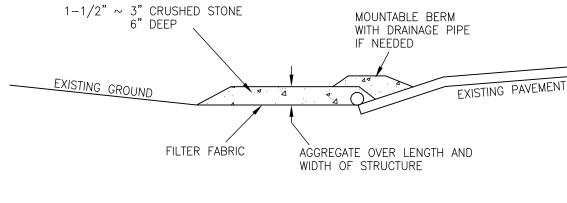PLAINVILLE, MA 02762 Development Company, L

320 SOUTH STREET

10 Commerce Blvd

320 SOUTH STREET

PLAINVILLE, MA 02762

PROJECT:

<u>OWNER:</u>

Wrentham,

WBH, LLC

<u>APPLICANT:</u>

EDGEWOOD

DEVELOPMENT

COMPANY, LLC

Massachusetts

Professional Civil Engineers & Professional Land Surveyors

FOUR SCHOOL STREET P.O. BOX 9136 FOXBOROUGH, MA 02035 508-543-3939

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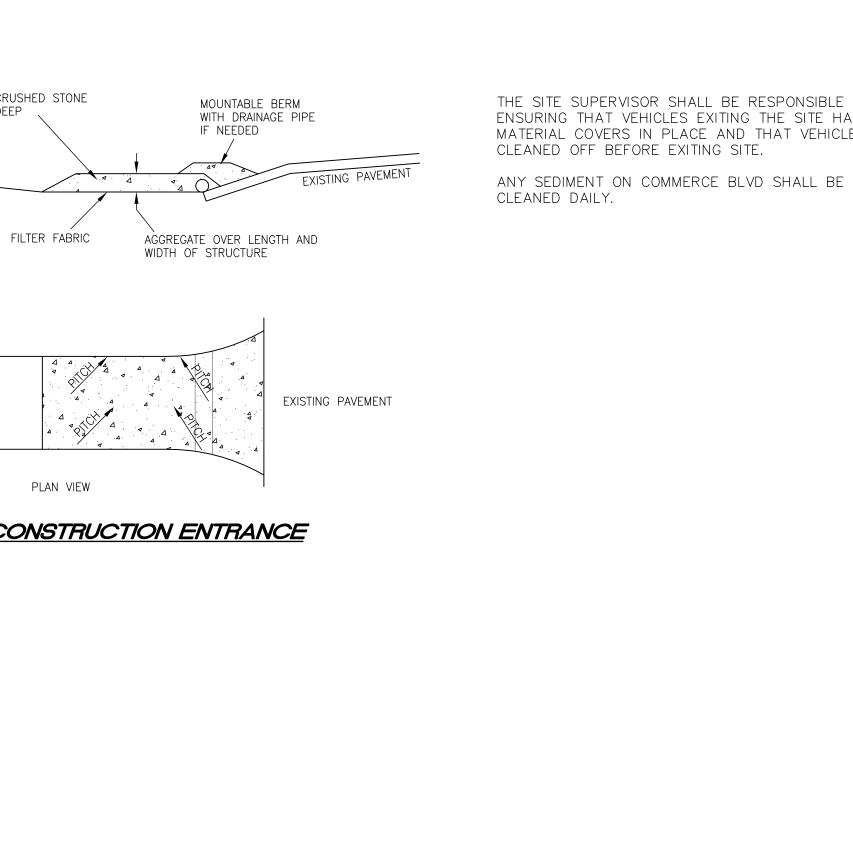
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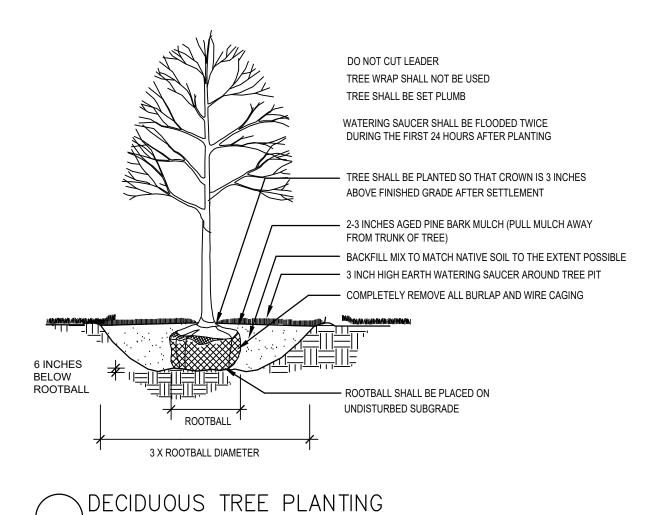
SWPPP DETAILS

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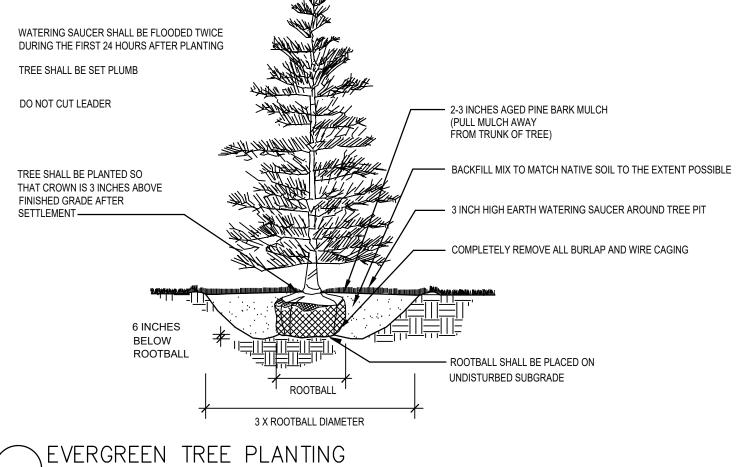
APRIL 19, 2023

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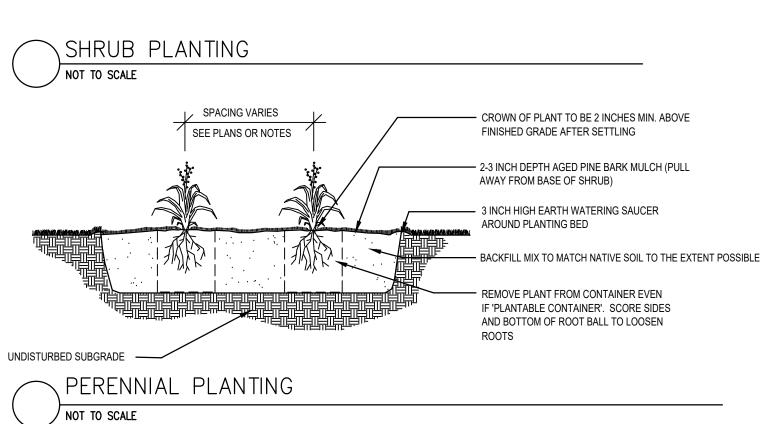








RAISE AND REPLANT ANY SHRUBS WHICH SETTLE MORE THAN 2 INCHES AFTER PLANTING & WATERING IN	
SHRUBS SHALL BE SET PLUMB	SHRUB SHALL BE PLANTED SO THAT CROWN IS 2 INCH MIN. ABOVE FINISHED GRADE AFTER SETTLEMENT
WATER BY FLOODING TWICE IN FIRST TWO HOURS AFTER PLANTING. WATER & MAINTAIN AS PER STANDARD SPECIFICATIONS EXCAVATE TO REQUIRED DEPTH AND BACKFILL WITH PLANTING MIX	2-3 INCH DEPTH AGED PINE BARK MULCH (PULL AWAY FROM BASE OF SHRUB) BACKFILL MIX TO MATCH NATIVE SOIL TO THE EXTENT POSSIBLE 3 INCH HIGH EARTH WATERING SAUCER AROUND PIT
150mm BELOW ROOTBALL 3 X ROOTBALL	CONTAINER PRIOR TO PLANTING UNDISTURBED SUBGRADE LOOSE OR CRACKED ROOTBALLS WILL NOT BE ACCEPTED FOR PLANTING
CLIDLID DI ANTINO	



PLANTING NOTES

- 1. FURNISH AND INSTALL PLANTS AS SHOWN. CONTRACTOR SHALL BE RESPONSIBLE FOR QUANTITY OF SHRUBS GRAPHICALLY SHOWN ON
- PLANS. IF THERE IS A DISCREPANCY BETWEEN PLANT LIST QUANTITIES AND GRAPHICS, THE GRAPHIC SHALL TAKE PRECEDENCE.

 2. PRIOR TO THE START OF EXCAVATION FOR THE PROJECT BOTH ON AND OF THE SITE, THE CONTRACTOR SHALL NOTIFY DIGSAFE AND BE PROVIDED A DIGSAFE NUMBER INDICATING THAT EXISTING UTILITIES HAVE BEEN LOCATED AND MARKED.
- 3. CONTRACTOR SHALL BEGIN 90 DAY MAINTENANCE PERIOD IMMEDIATELY UPON PLANTING AND WILL CONTINUE UNTIL FINAL ACCEPTANCE.
- 4. CONTRACTOR SHALL VERIFY TREE REMOVALS WITH LANDSCAPE ARCHITECT PRIOR TO CONSTRUCTION START.
 5. CONTRACTOR SHALL MAINTAIN POSITIVE DRAINAGE AWAY FROM BUILDING FOUNDATIONS, STRUCTURES, AND PLANTING BEDS.
- 5. MAXIMUM SLOPE WITHIN DISTURBED AREAS SHALL NOT EXCEED 3:1, UNLESS OTHERWISE NOTED.
- 7. PLANTS SHALL BEAR THE SAME RELATIONSHIP TO FINISH GRADE AS TO ORIGINAL GRADES BEFORE DIGGING. 8. PLANT MATERIALS SHALL CONFORM TO THE GUIDELINES ESTABLISHED BY "THE AMERICAN STANDARD FOR NURSERY STOCK", PUBLISHED BY
- THE AMERICAN ASSOCIATION OF NURSERYMEN. 9. PLANTS TO ARRIVE AT SITE BALLED IN BURLAP OR CONTAINERIZED. 10. MULCH FOR PLANTED AREAS TO BE AGED PINE BARK: PARTIALLY DECOMPOSED, DARK BROWN IN COLOR AND FREE OF WOOD CHIPS THICKER
- THAN 1/4 INCH. 11. PLANTING SOIL MIX: AMEND SOIL TO MATCH EXISTING NATIVE SOIL TO THE EXTENT POSSIBLE. LOAM THOROUGHLY INCORPORATED WITH
- ROTTED MANURE PROPORTIONED 5 C.Y. TO 1 C.Y. OR EQUIVALENT. USE OF PEAT MOSS IS PROHIBITED.
- 12. THE LANDSCAPE CONTRACTOR SHALL GUARANTEE PLANT MATERIALS FOR ONE (1) FULL YEAR FROM DATE OF ACCEPTANCE. REQUEST THE LANDSCAPE ARCHITECT PROVIDE A WRITTEN LETTER OF ACCEPTANCE UPON COMPLETION OF EACH PHASE.
- 13. PLANT MATERIALS ARE SUBJECT TO THE APPROVAL OF THE LANDSCAPE ARCHITECT, AT THE NURSERY, AND AT THE SITE.
- 14. LANDSCAPE ARCHITECT TO FLAG TREES TO BE TRANSPLANTED PRIOR TO CONSTRUCTION START. 15. AREAS OF THE SITE WHICH HAVE BEEN DISTURBED AND NOT OTHERWISE DEVELOPED SHALL BE LOAMED WITH TOPSOIL TO A MINIMUM DEPTH
- OF 6", AND SEEDED WITH A MIX CONSISTING OF 40% PERENNIAL RYE GRASS; 30% CHEWINGS FESCUE; 30% KENTUCKY BLUEGRASS. 16. SCREENED IMAGES SHOW EXISTING CONDITIONS. WHERE EXISTING CONDITIONS LIE UNDER OR ARE IMPINGED UPON BY PROPOSED BUILDINGS
- AND/OR SITE ELEMENTS, THE EXISTING CONDITION WILL BE REMOVED, ABANDONDED AND/OR CAPPED OR DEMOLISHED AS REQUIRED. 17. THERE SHALL BE NO SUBSTITUTION OF PLANT SPECIES WITHOUT AUTHORIZATION BY THE LANDSCAPE ARCHITECT.
- 18. NO PLANTING SHALL BE INSTALLED BEFORE ACCEPTANCE OF ROUGH GRADING.
- 19. PLANTS TO BE THOROUGHLY WATERED AFTER INSTALLATION, AT LEAST TWICE WITHIN THE FIRST 24 HOURS. WATER TREES SUFFICIENTLY TO KEEP SOIL MOIST DURING DRY PERIODS FOR THE FIRST TWO GROWING SEASONS.

	PLANT SCHEDULE			
Qty.	Common Name	Latin Name	Scheduled Size	Remarks
	Trees			
4	Autumn Blaze® Maple	Acer x freemanii 'Jeffsred'	3"-3.5" Cal.	B&B, Full, Symmetrical, High Branched
5	Princeton Elm	Ulmus americana 'Princeton'	3"-3.5" Cal.	B&B, Full, Symmetrical, High Branched
6	Skyline Honeylocust	Gleditsia triacanthos inermis 'Skyline'	3"-3.5" Cal.	B&B, Full, Symmetrical, High Branched
	Evergreen Trees			
2	llex opaca	American Holly	8'-10' Ht.	B&B, full, symmetrical, strong central leader
3	Eastern Red Cedar	Juniperus virginiana	8'-10' Ht.	B&B, full, symmetrical, strong central leader
3	White Fir	Abies concolor	8'-10' Ht.	B&B, full, symmetrical, strong central leader
	Shrubs			
5	Arnold Promise Witch Hazel	Hamamelis x intermedia 'Arnold Promise'	5'-6' Ht.	B&B, multistem
79	Bar Harbor Juniper	Juniperus horizontalis 'Bar Harbor'	5 Gal.	Container
39	Blushing Knock Out Rose	Rosa x 'Blushing Knock Out'	5 Gal.	Container
18	Border Forsythia	Forsythia intermedia	5 Gal.	Container
11	Chicago Lustre Viburnum	Viburnum dentatum 'Chicago Lustre'	7 Gal.	Container
15	Little Devil Ninebark	Physocarpus opulifolius "Little Devil"	5 Gal.	Container
10	Minuet Weigela	Weigela florida 'Minuet'	5 Gal.	Container
14	Shamrock Holly	llex glabra 'Shamrock'		
	Grasses, Perennials and Groundcovers			
142	Black Eyed Susan	Rudbeckia 'American Gold Rush'	1 Gal.	Container
121	Blue Spire Russian Sage	Perovskia atriplicifolia 'Blue Spire'	1 Gal.	Container
15	Hubricht's bluestar	Amsonia hubrichtii	1 Gal.	Container
45	Magnus Coneflower	Echinacea purpurea 'Magnus'	1 Gal.	Container
148	Rosy Returns Daylily	Hemerocallis x 'Rosy Returns'	1 Gal.	Container
22	Showy Goldenrod	Solidago speciosa	1 Gal.	Container
146	Dwarf Fountain Grass	Pennisetum alopecuroides 'HameIn'	2 Gal.	Container
111	Little Bluestem	Schizachyrium scoparium	2 Gal.	Container
51	Shenandoah Switch Grass	Panicum virgatum 'Shenandoah'	2 Gal.	Container
98	Transparent Moor Grass	Molinia caerulea subsp. arundinacea 'Transparent'	2 Gal.	Container

10 Commerce Boulevard

Wrentham, MA

Owner


WBH, LLC 3 Belcher Street Plainville, MA 02762

Applicant

EDGEWOOD **DEVELOPMENT** COMPANY, LLC 3 BELCHER STREET PLAINVILLE, MA 02762



Civil Engineer

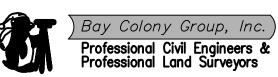

Landscape Architect



Radner Design Associates, Inc.

3 Allied Drive, Suite 303 Dedham, MA 02026 508.736.6144 www.RadnerDesign.com

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Revision:

Checked by: mr

Scale: N.A.



Sheet Name: Notes and Details


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Issue Date: 04/19/2023

Sheet No.:

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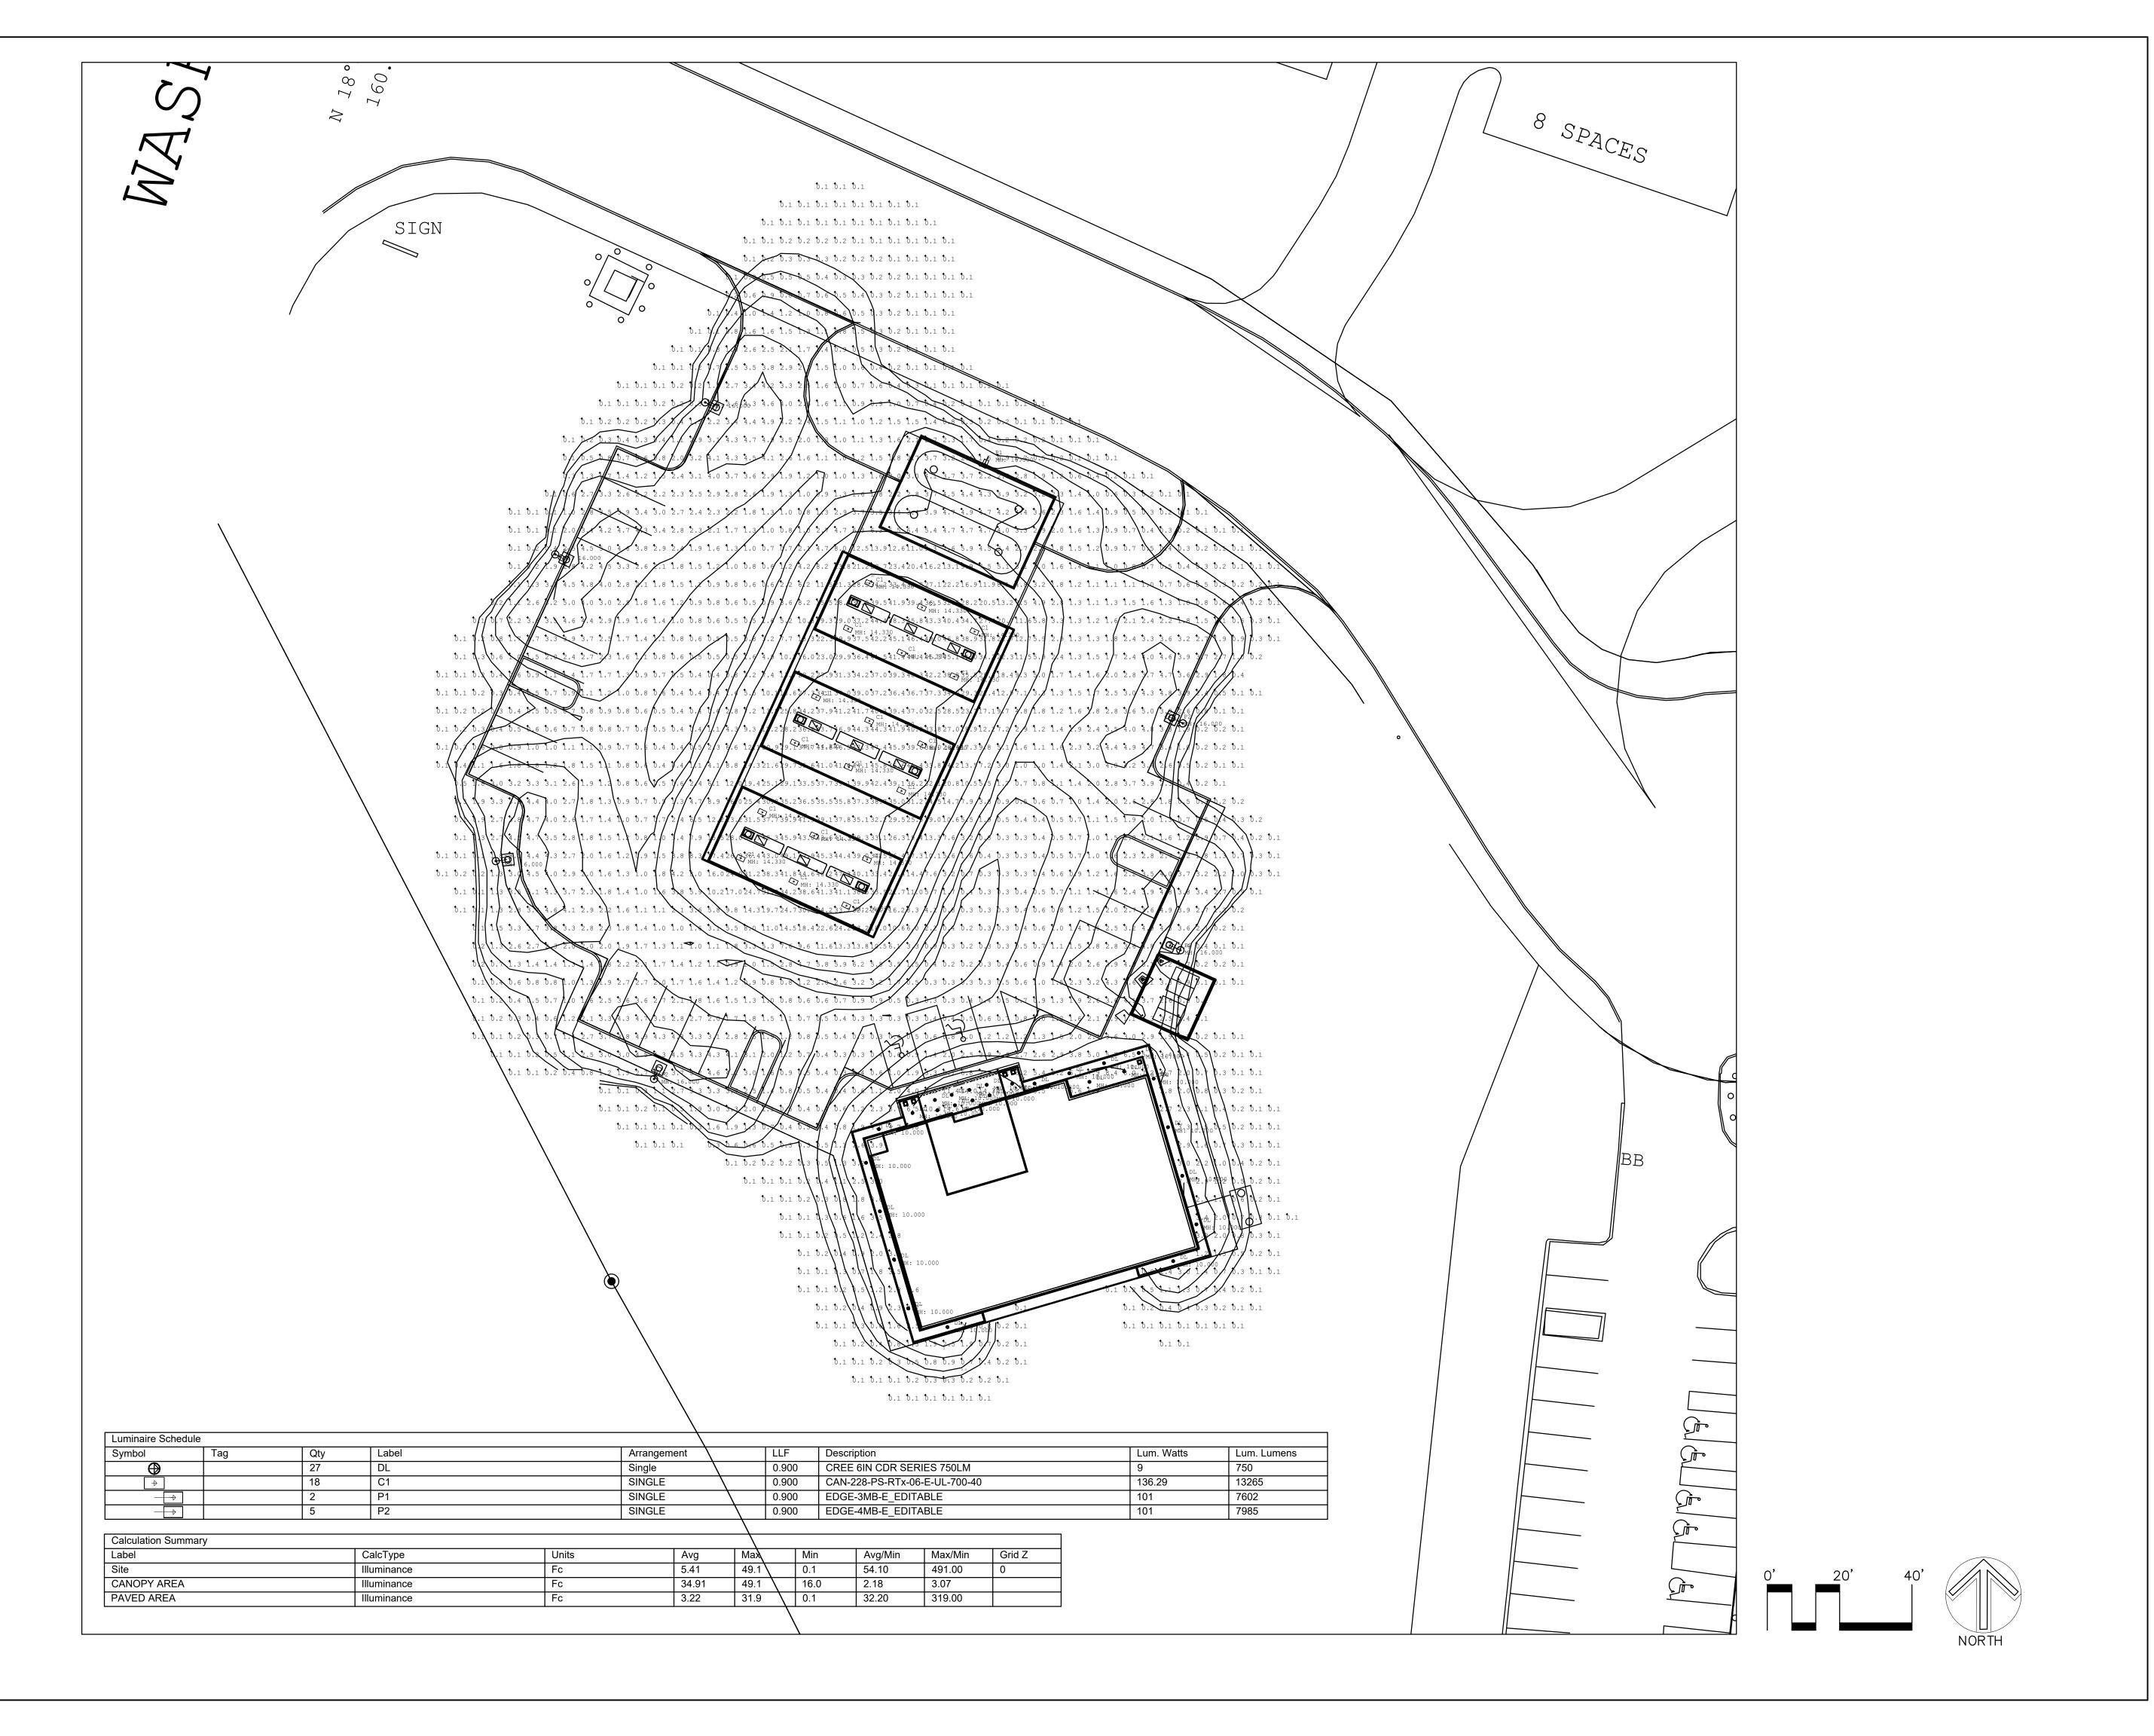




Shading Calculations
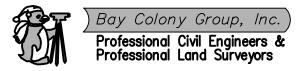
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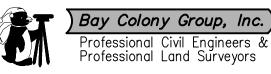
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Sheet Name: Site Lighting Photometric Plan

Project No.: 22-03

Issue Date: 04/19/2023


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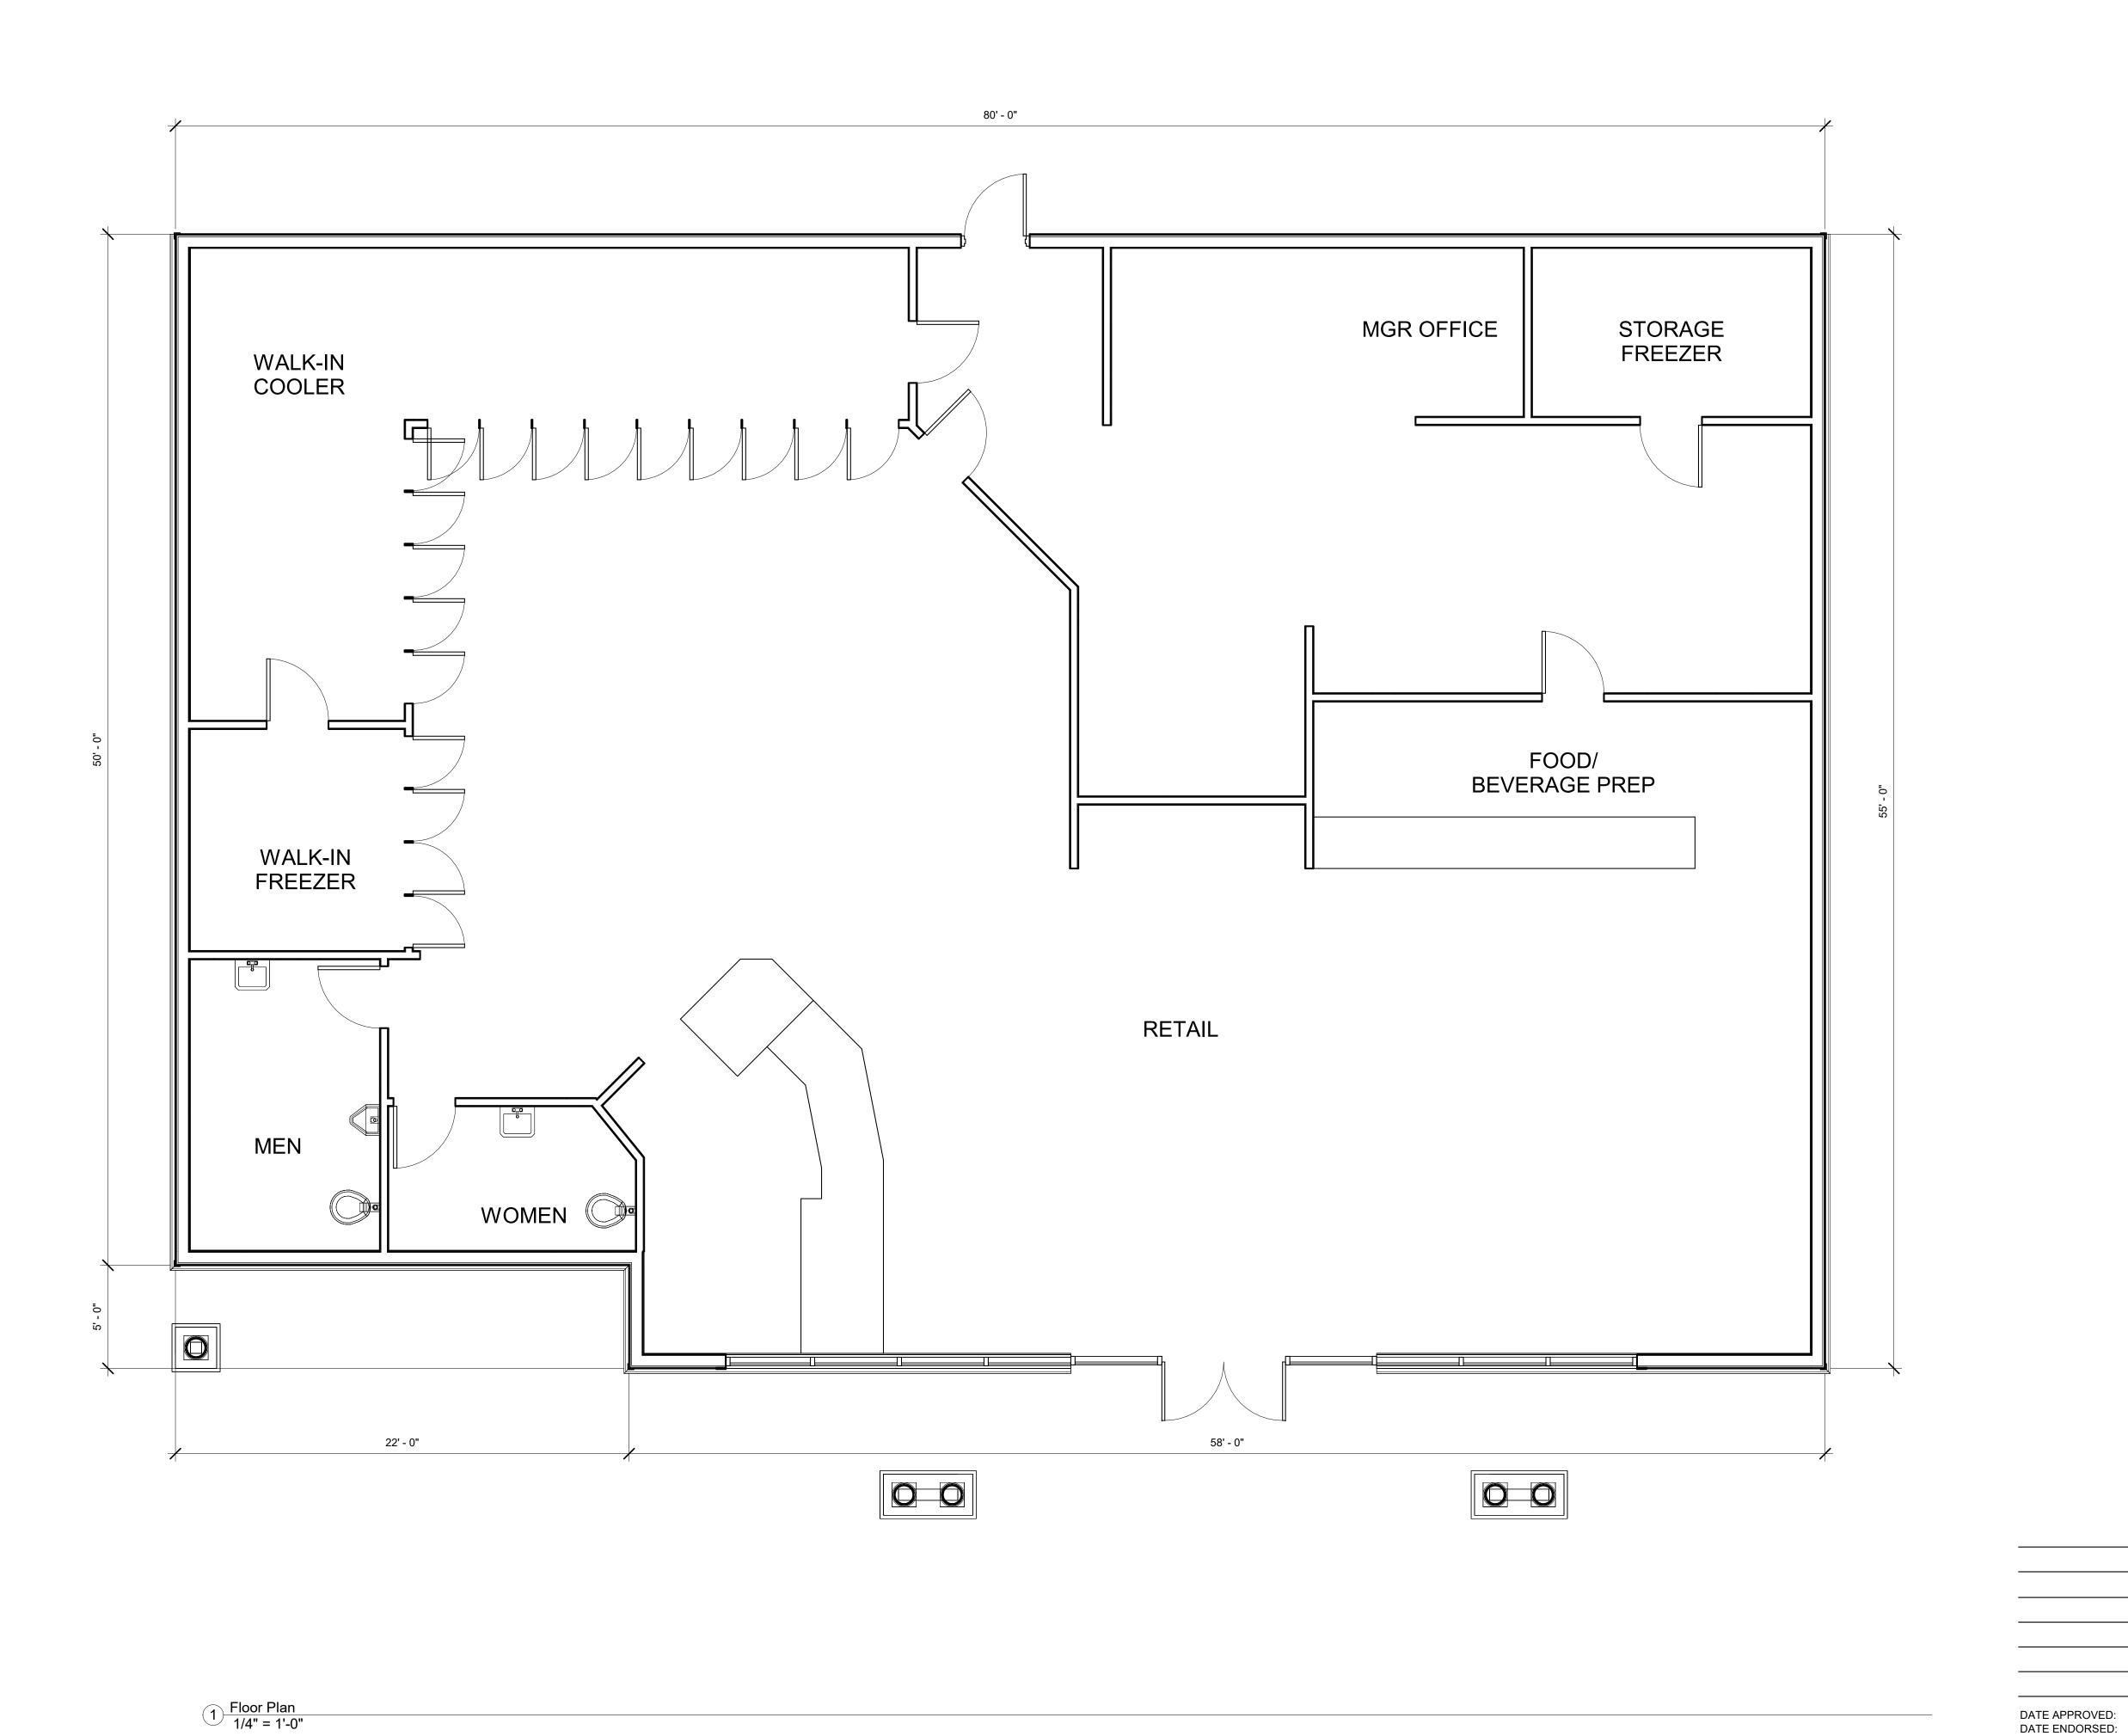




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WRENTHAM PLANNING BOARD

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DATE WRENTHAM TOWN CLERK

21187

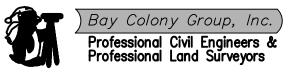

21187

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